# #101 & #102 7425 20 St. SE - Building 1

4-UNIT W/. 4 SUITES **MULTI-FAMILY** DEVELOPMENT

LOTS 12 & 13, BLOCK 8, PLAN 955 AV

OGDEN, SE CALGARY LOT ZONING: R-CG

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**SECTIONS & DETAILS** 

DETAILS & NOTES



### EXTERIOR 3D PERSPECTIVE - FOR DESIGN PURPOSE ONLY SCALE: N.T.S.

# **Building Statistics**

### **BUILDING HEIGHT**

### **BUILDING 1**

MAXIMUM BUILDING HEIGHT PLANE = 11.00m

PROPOSED PEAK GEODETIC = 1034.27

PROPOSED MAIN FLOOR GEODETIC = 1025.45

LOWEST ADJACENT GRADE = 1023.93

PROPOSED HEIGHT = 10.34m

### **BUILDING 2**

MAXIMUM BUILDING HEIGHT PLANE = 8.60m

PROPOSED PEAK GEODETIC = 1032.32

PROPOSED MAIN FLOOR GEODETIC = 1025.45

LOWEST ADJACENT GRADE = 1023.81

PROPOSED HEIGHT = 8.51m

### RESIDENTIAL DENSITY Lot area = $\sim 0.0556$ ha

71.94 units/ha

Units = 4

### PARCEL COVERAGE 53.76 %

Lot area = 555.62 m2 Building 1 footprint = 111.17 m2 Building 2 footprint = 109.19 m2 Garage footprint = 78.35 m<sup>2</sup> Covered entries = 00.00 m2 Total coverage area = 298.71 m2

### SHARED AMENITY SPACE 79.46 m<sup>2</sup>

### TOTAL GROSS FLOOR AREA 220.38 m2 TOTAL = 2372 sf 220.38 m2Unit A1 598.00 sf (55.56 m2)

Unit B1 598.00 sf (55.56 m2) Unit C1 588.00 sf 54.63 m2) Unit D1 588.00 sf (54.63 m2)

### FRONT SETBACK

Required front setback = 3.00m Proposed front setback = 3.00m

### PARKING STALLS PROVIDED ON-SITE 4.0

**DWELLING UNITS: 4** PARKING STALLS PER DWELLING UNIT = 1 VISITOR STALLS PER DWELLING UNIT = 0 PARKING STALLS PROVIDED: 4 PROVIDED VIA GARAGE PARKING

### TOTAL LANDSCAPED AREA 233.27 m2

Site area = 555.62 m2 Covered area = 298.71 m2 Concrete Apron = 13.01 m2 Mobility Storage Lockers/Class 1 Lockers = 10.62m2 Total Coverage Area = 322.35 m2 Landscaped Area = 233.27 m2 (2510.90 sf)

HARD LANDSCAPE = 56.97% Concrete 132.89 m2 TOTAL 132.89 m2

SOFT LANDSCAPE = 43.03% Sod 57.37 m2 Mulch 12.54 m2 Permeable Pavers 30.47 m2 TOTAL 100.38 m2

### **REQUIRED PLANTINGS**

A minimum of 1.0 tree & 3.0 shrubs must be provided for each 110 m2 of parcel area Lot area = 555.62 m2 / 110 = 5.05 Trees -  $1.0 \times 5.05 = 5.05 = 6$ Shrubs -  $3.0 \times 5.05 = 15.15 = 16$ Plantings required = 22

Plantings provided = 22 Trees = 6 Shrubs = 16

# NATIONAL BUILDING CODE - 2023 ALBERTA EDITION

### 9.9.1.3. OCCUPANT LOAD

(2) The occupant load for the dwelling units shall be based on 2 persons per bedroom or sleeping area.

Occupant load for Unit H is 2; Occupant load for Unit A, B, C, D, & E is 6; Occupant load for Unit F, & G is 8.

# 9.10.2.1. BUILDING CLASSIFICATION: GROUP C - RESIDENTIAL OCCUPANCIES

This applies to all the buildings on site including the accessory building.

### 9.10.9.11. SEPARATION OF RESIDENTIAL OCCUPANCIES

(1) Except as provided in Sentence (2), residential occupancies shall be separated from all other major occupancies by a fire separation having a fire-resistance rating of not less than 1 h.

### 9.10.9.14. SEPARATION OF RESIDENTIAL SUITES

(1) Except as provided in Sentences (2), (3) and (4) and Part 10, suites in residential occupancies shall be separated from adjacent rooms and suites by a fire separation having a fire-resistance rating of not less than 45 min.

(3) Except as provided in Sentence (4), dwelling units that contain 2 or more storeys including basements shall be separated from the remainder of the building by a fire separation having a fire-resistance rating of not less than 1 h.

### 9.10.11.2. FIREWALLS NOT REQUIRED

(1) Except as stated in Sentence (2), a party wall on a property line of a building of residential occupancy need not be constructed as a firewall, provided it is constructed as a fire separation having not less than a 1h fire-resistance rating, where the party wall separates:

(a) two dwelling units where there is no dwelling unit above another dwelling unit (2) Where a building of residential occupancy contains more than 2 houses, a party wall that separated any 2 adjacent houses with a secondary suite from the rest of the building shall be constructed as a firewall to create separate buildings each containing no more than 2 adjacent houses with a secondary suite. (3) The wall described in sentence (1) shall provide continuous protection from the top of the footings to the

### 9.10.11.3. CONSTRUCTION OF FIREWALLS

underside of the roof deck.

(1) Where firewalls are used, the requirements in Part 3 shall apply.

(2) A firewall that separates a building or buildings with floor areas containing major occupancies other than Group E of Group F, Division 1 or 2 shall be constructed as a fire separation of noncombustible construction having a fire-resistance rating of not less than 2 h.

(3) Except as permitted by Sentence (4), the required fire-resistance rating of a firewall, except for closures, shall be provided by masonry or concrete.

### 3.1.10.3. CONTINUITY OF FIREWALLS

(1) A firewall shall extend from the ground continuously through, or adjacent to, all storeys of a building or buildings so separated, except that a firewall located above a basement storage garage conforming to Article 3.2.1.2. is permitted to commence at the floor assembly immediately above the storage garage.

### 3.1.10.4. PARAPETS

(1) Except as permitted by Sentences (2) and 3.1.10.3.(2), a firewall shall extend above the roof surface to form a parapet not less than

a) 150mm high for a firewall required to have a fire-resistance rating of not less than 2h

### 3.1.10.7. COMBUSTIBLE PROJECTIONS

(2) If buildings are separated by a firewall, combustible projections on the exterior of one building, including balconies, platforms, canopies, eave projections and stairs, that extend outward beyond the end of the firewall, shall not be permitted within 2.4m of combustible projections and window or door openings of the adjacent building. (See also Article 3.2.3.6.)

### 3.2.3.6. COMBUSTIBLE PROJECTIONS

(1) Except for a building containing one or 2 dwelling units only, combustible projections on the exterior of a wall that could expose an adjacent building to fire spread and are more than 1m above ground level, including balconies, platforms, canopies and stairs, shall not be permitted within a) 1.2m of a property line or the centre line of a public way, or

b) 2.4m of a combustible projection on another building on the same property.

**NEW CENTURY DESIGN** 

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**RESPONSIBILITIES** 

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AREAS TOTAL GROSS FLOOR AREA S.F. #102 7425 UNIT A1 TOTAL 1243 MAIN **UPPER** #102B SUITE A2 404 #101 7425 UNIT B1 TOTAL 1243 MAIN 598 **UPPER** 645 #101B SUITE B2 404 #202 7425 UNIT C1 TOTAL 1221 MAIN 588 **UPPER** 633 #202B SUITE C2 395 #201 7425 UNIT D1 TOTAL 1221

STREET ADDRESS

MAIN

UPPER

#201B SUITE D2

#101 & #102 7425 20 St. SE

588

633

LEGAL ADDRESS

LOTS 12 & 13, BLOCK 8, PLAN 955AV

PROJECT

OGDEN MID-BLOCK DEVELOPMENT **BUILDING 1** 

CHECKED: DK DESIGN/DRAWN: DK PROJECT# 23-3-CL-CN-036 SCALE

**AS NOTED** 

TITLE


**COVER PAGE** 

R-CG ZONING


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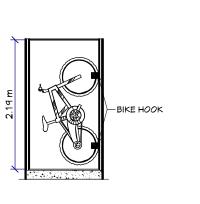
# SITE PLAN NOTES

 SOD TO BE DROUGHT TOLERANT GRASS SPECIES • SITE TO BE IRRIGATED BY UNDERGROUND LOW WATER IRRIGATION SYSTEM

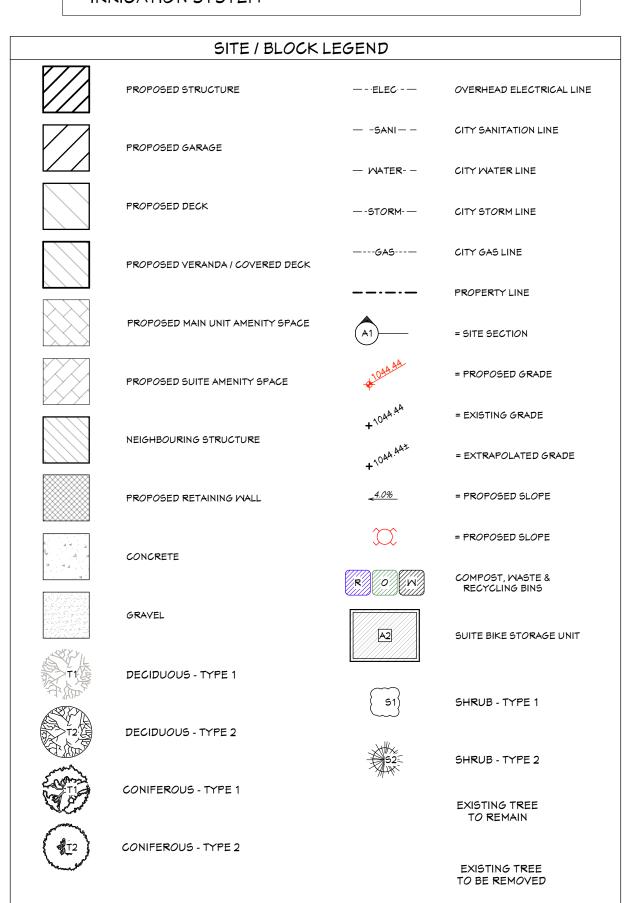

				TRE	<u>ELEGEND</u>	
#	DIA.	CAN.	HGT.	TYPE	SPECIES	STATUS
T1		0.77	2.20	BUSH		TO BE REMOVED
T2	0.56	13.00	20.00	DECIDUOUS		TO REMAIN
T3	0.10	0.90	4.00	CONIFEROUS		TO BE REMOVED
T4		1.40	1.55	BUSH		TO BE REMOVED
T5	0.15	7.15	10.00	DECIDUOUS		TO BE REMOVED
T6		2.50	3.00	BUSH		TO BE REMOVED
PROPO	SED			PROPOSED		PROPOSED
T7	0.06		2.00	CONIFEROUS	WHITE CEDAR	TO BE PLANTED(x3)
Τ8	0.06		2.00	DECIDUOUS	COLUMNAR ASPEN	TO BE PLANTED(x3)
51		0.60	0.60	ALPINE CURRAN	IT	TO BE PLANTED(x8)
52		0.60	0.60	JUNIPER		TO BE PLANTED(x8)



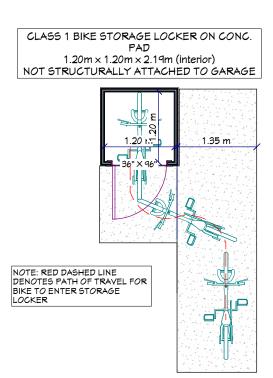



NOTE: RED DASHED LINE DENOTES PATH OF TRAVEL FOR BIKE TO ENTER STORAGE

ALTERNATIVE MOBILITY STORAGE LOCKERS ON CONC. PAD
2.80m x 1.20m x 2.19m (interior)
NOT STRUCTURALLY ATTACHED TO GARAGE



SCALE: NTS - FOR ILLUSTRATION PURPOSES

-1'-7" HEEL HEIGHT

\_ 10 : 12

**ROOF PLAN** 

SCALE: 1/4" = 1'-0"

10:12

SKYLIGHT  $22 \times 48$ 

10:12

-LINE OF WALL BELOW

51----

1'-7" HEEL HEIGHT-

< 10 : 12

1'-7" HEEL HEIGHT-

10 : 12

SKYLIGHT 22×48

10 : 12 🔍

- (51)

LINE OF WALL BELOW-

LOCKER ACCESS DIAGRAMS <sup>)</sup> SCALE: 3/16" = 1'-0"



Curb Cut

6.10 GRAVEL LANE

ned

CONC. APRONT

ORW

12.00m Rear Setbac

SHARED AMENITY

∕∕design & grades

#101 **7**42**5** 20 ST. SE

MATER METERS

3.05 BOW (EXISTING)

Fence Enc.

1.35 into Road

6.00m Front Setback

0.6%

GARAGE - SEPARATE BP APPLICATION

O R W W R O

IMAGINARY PROPERTY LINE PROPSOED CONC. WALKWAY

BUILDING 2 - SEPARATE BP APPLICATION

LDING TO BE FULLY SPRINKLEREI UNIT C&D

TOJ = 1025.45

PEAK = 1032.32

ATF = 1022.53

PROPOSED 2 UNIT W/2 BSMT

12.50 7.54 × 0.76 UPPER CANT.

BLDG 1 UNIT A & B

MAIN= 1025.45

PEAK = 1034.27 ATF = 1022.53

LOTS 12 & 13

BLOCK 8 PLAN 955AV

PROPOSED 2

UNIT W/ 2 BSMT

SUITES

BUILDING TO BE FULLY SPRINKLERED

179° 52' 03"

1.07M CITY SIDEWALK

EXISTING PUBLIC SIDEWALK TO BE REMOVED & A NEW 1.5M WIDE PUBLIC SIDEWALK SHALL BE POURED AT THE EXPENSE OF THE DEVELOPER

#7425 20 STREET SE

NOTE: AN URBAN FORESTRY TECHNICIAN MUST BE ON-SITE FOR ALL OPEN EXCAVATION WITHIN 3 M OF THE PUBLIC TREE (T2 - GREEN ASH) IN

ORDER TO MITIGATE ANY DAMAGE TO THE
PUBLIC TREE. CONTACT URBAN FORESTRY BY
PHONING 311 AT LEAST THREE (3) BUSINESS
DAYS IN ADVANCE OF EXCAVATION

4.12 BOC

EXISTING CURB CUT TO BE REMOVED AND REHABILITATED AT THE DEVELOPERS EXPENSE

2.57 BOW

imaginary setback line for spacial calc.

Ponding curb- See futrue DSSP for

# **RESPONSIBILITIES**

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BP Set	04.24.25
BP Set 1.01	06.19.25

S.F.

# AREAS TOTAL GROSS FLOOR AREA

#102 7425 UNIT A1	TOTAL	1243
MAIN		598
UPPER		645
#102B SUITE	A2	404
#101 7425 UNIT B1	TOTAL	1243
MAIN		598
UPPER		645
#101B SUITE	B2	404
#202 7425 UNIT C1	TOTAL	1221
MAIN		588
UPPER		633
#202B SUITE	C2	395
#201 7425 UNIT D1	TOTAL	1221
MAIN		588
UPPER		633
#201B SUITE	D2	395

# STREET ADDRESS

#101 & #102 7425 20 St. SE

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LOTS 12 & 13, BLOCK 8, PLAN 955AV

PROJECT

OGDEN MID-BLOCK DEVELOPMENT **BUILDING 1** 

DESIGN/DRAWN: DK PROJECT#


23-3-CL-CN-036 SCALE

**AS NOTED** 

CHECKED: DK

SITE PLAN & ROOF PLAN

R-CG ZONING

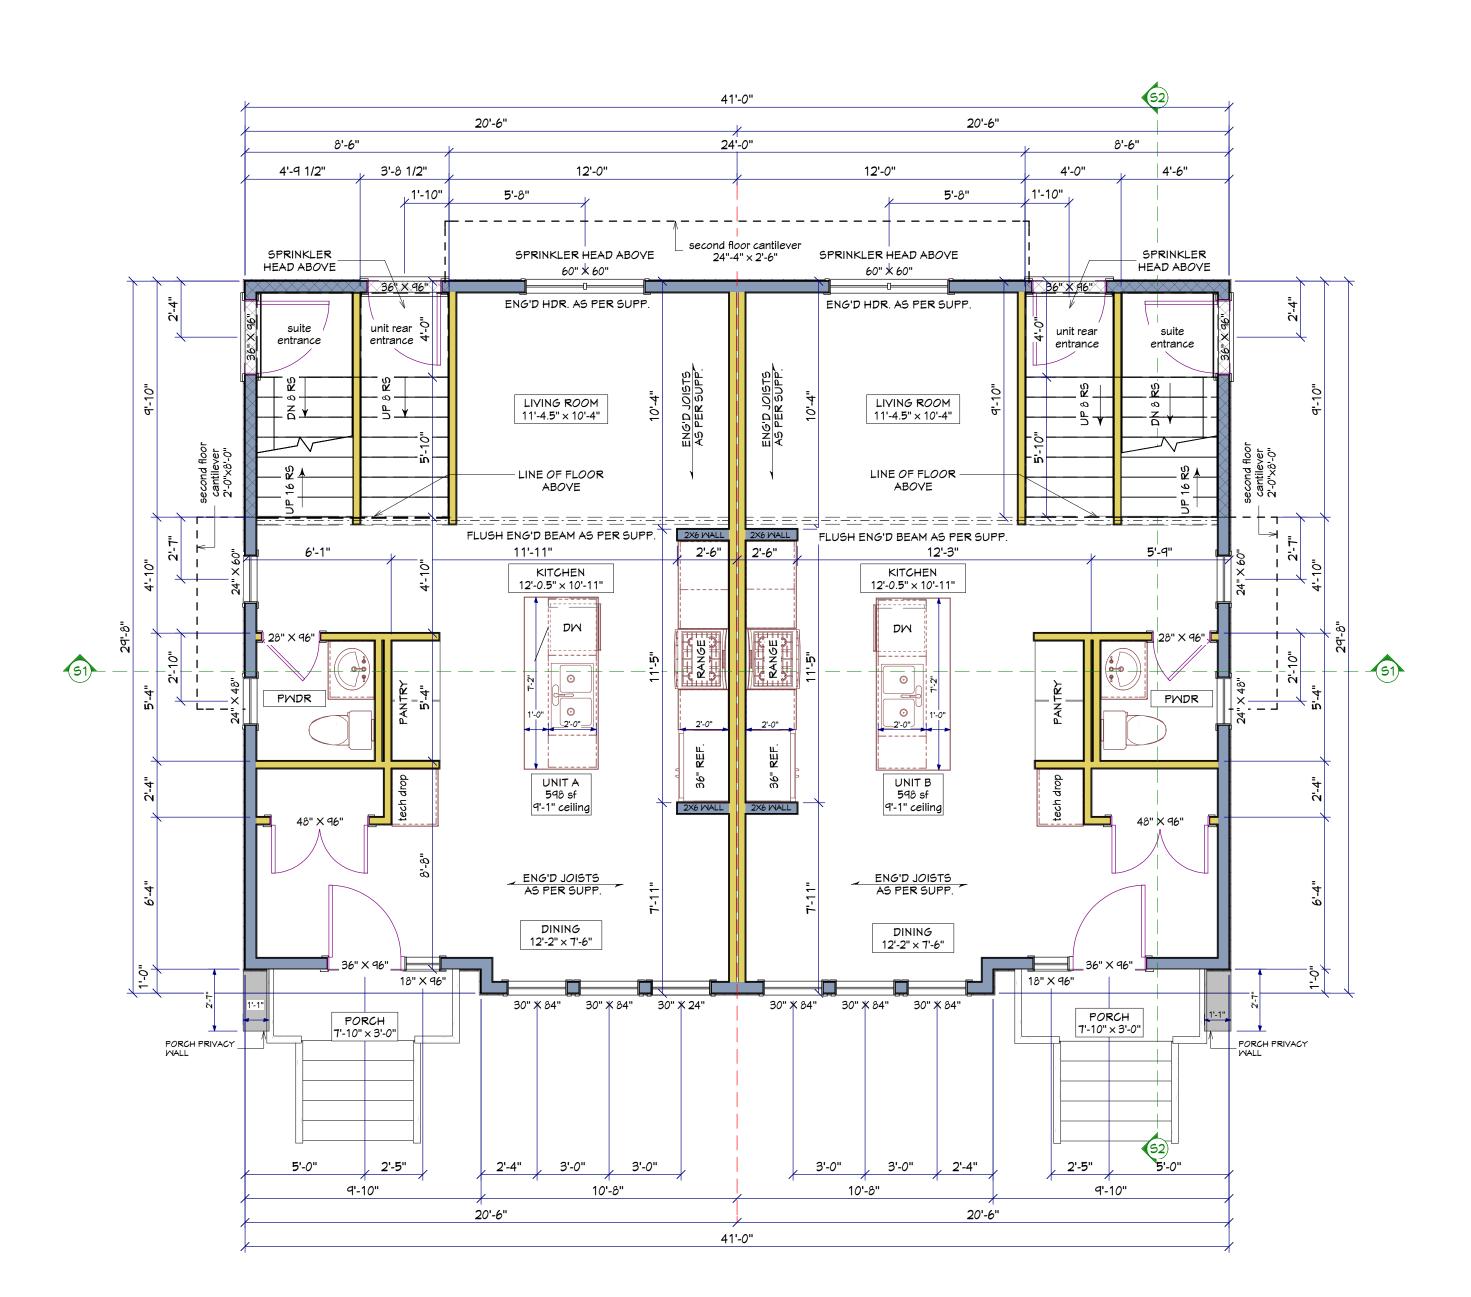

4'-6" 5'-0" 3'-11" 72" × 36" 72" 🗴 36" 24" × 54" — line of floor below line of floor below— BEDROOM 2 11'-7" × 9'-6" BEDROOM 2 11'-7" × 9'-6" **5**'-10" 8'-3 1/2" **5**'-10" BATHROOM δ'-0" × 5'-1" 8'-0" × **5**'-1" UNIT A 560 sf M.I.C ₹ 3'-10" × 5'-2" (51) BEDROOM 3 9'-6.5"× 8'-6" BEDROOM 3 9'-6.5"×8'-6" 10'-5 1/2" 10'-1" 5'-6 1/2" W vaulted T 36" × 24" ENSUITE ENSUITE | 36" × 24"-PRIMARY SUITE 9'-10.5"× 12'-0" SUITE 9'-10.5"× 12'-0" 48" X 36" SLIDER ENG'D TALL WALL ENG'D TALL MALL line of roof below — 2'-4" 3'-0" 3'-0" 3'-0" 3'-0" 2'-4" 10'-8" 9'-10" 9'-10" 10'-8" 2'-0" 20'-6" 20'-6"

45'-0"

12'-2"

2'-4"

9'-10"


8'-4"

12'-2"

9'-5"

MAIN FLOOR PLAN BLDG 1 SCALE: 1/4" = 1'-0"

UPPER FLOOR PLAN BLDG 1 SCALE: 1/4" = 1'-0"

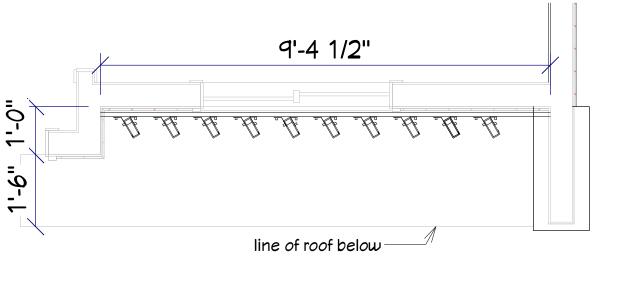

LOUVRES ENLARGED PLAN SCALE: 1/2" = 1'-0"

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BP Set	04.24.25
BP Set 1.01	06.19.25

# AREAS

S.F.

#102 7425 UNIT A1	TOTAL	
MAIN		
UPPER		
#102B SUITE	A2	
#101 7425 UNIT B1	TOTAL	
MAIN		
UPPER		
#101B SUITE	B2	
#202 7425 UNIT C1	TOTAL	
MAIN		
UPPER		
#202B SUITE	C2	
#201 7425 UNIT D1	TOTAL	
MAIN		
UPPER		
#201B SUITE	D2	

# STREET ADDRESS

#101 & #102 7425 20 St. SE

LEGAL ADDRESS

LOTS 12 & 13, BLOCK 8, PLAN 955AV

PROJECT

OGDEN MID-BLOCK DEVELOPMENT **BUILDING 1** 

23-3-CL-CN-036

CHECKED: DK DESIGN/DRAWN: DK

PROJECT#


SCALE

AS SHOWN

MAIN & UPPER FLOOR **PLANS** 

R-CG ZONING PAGE **A3** 



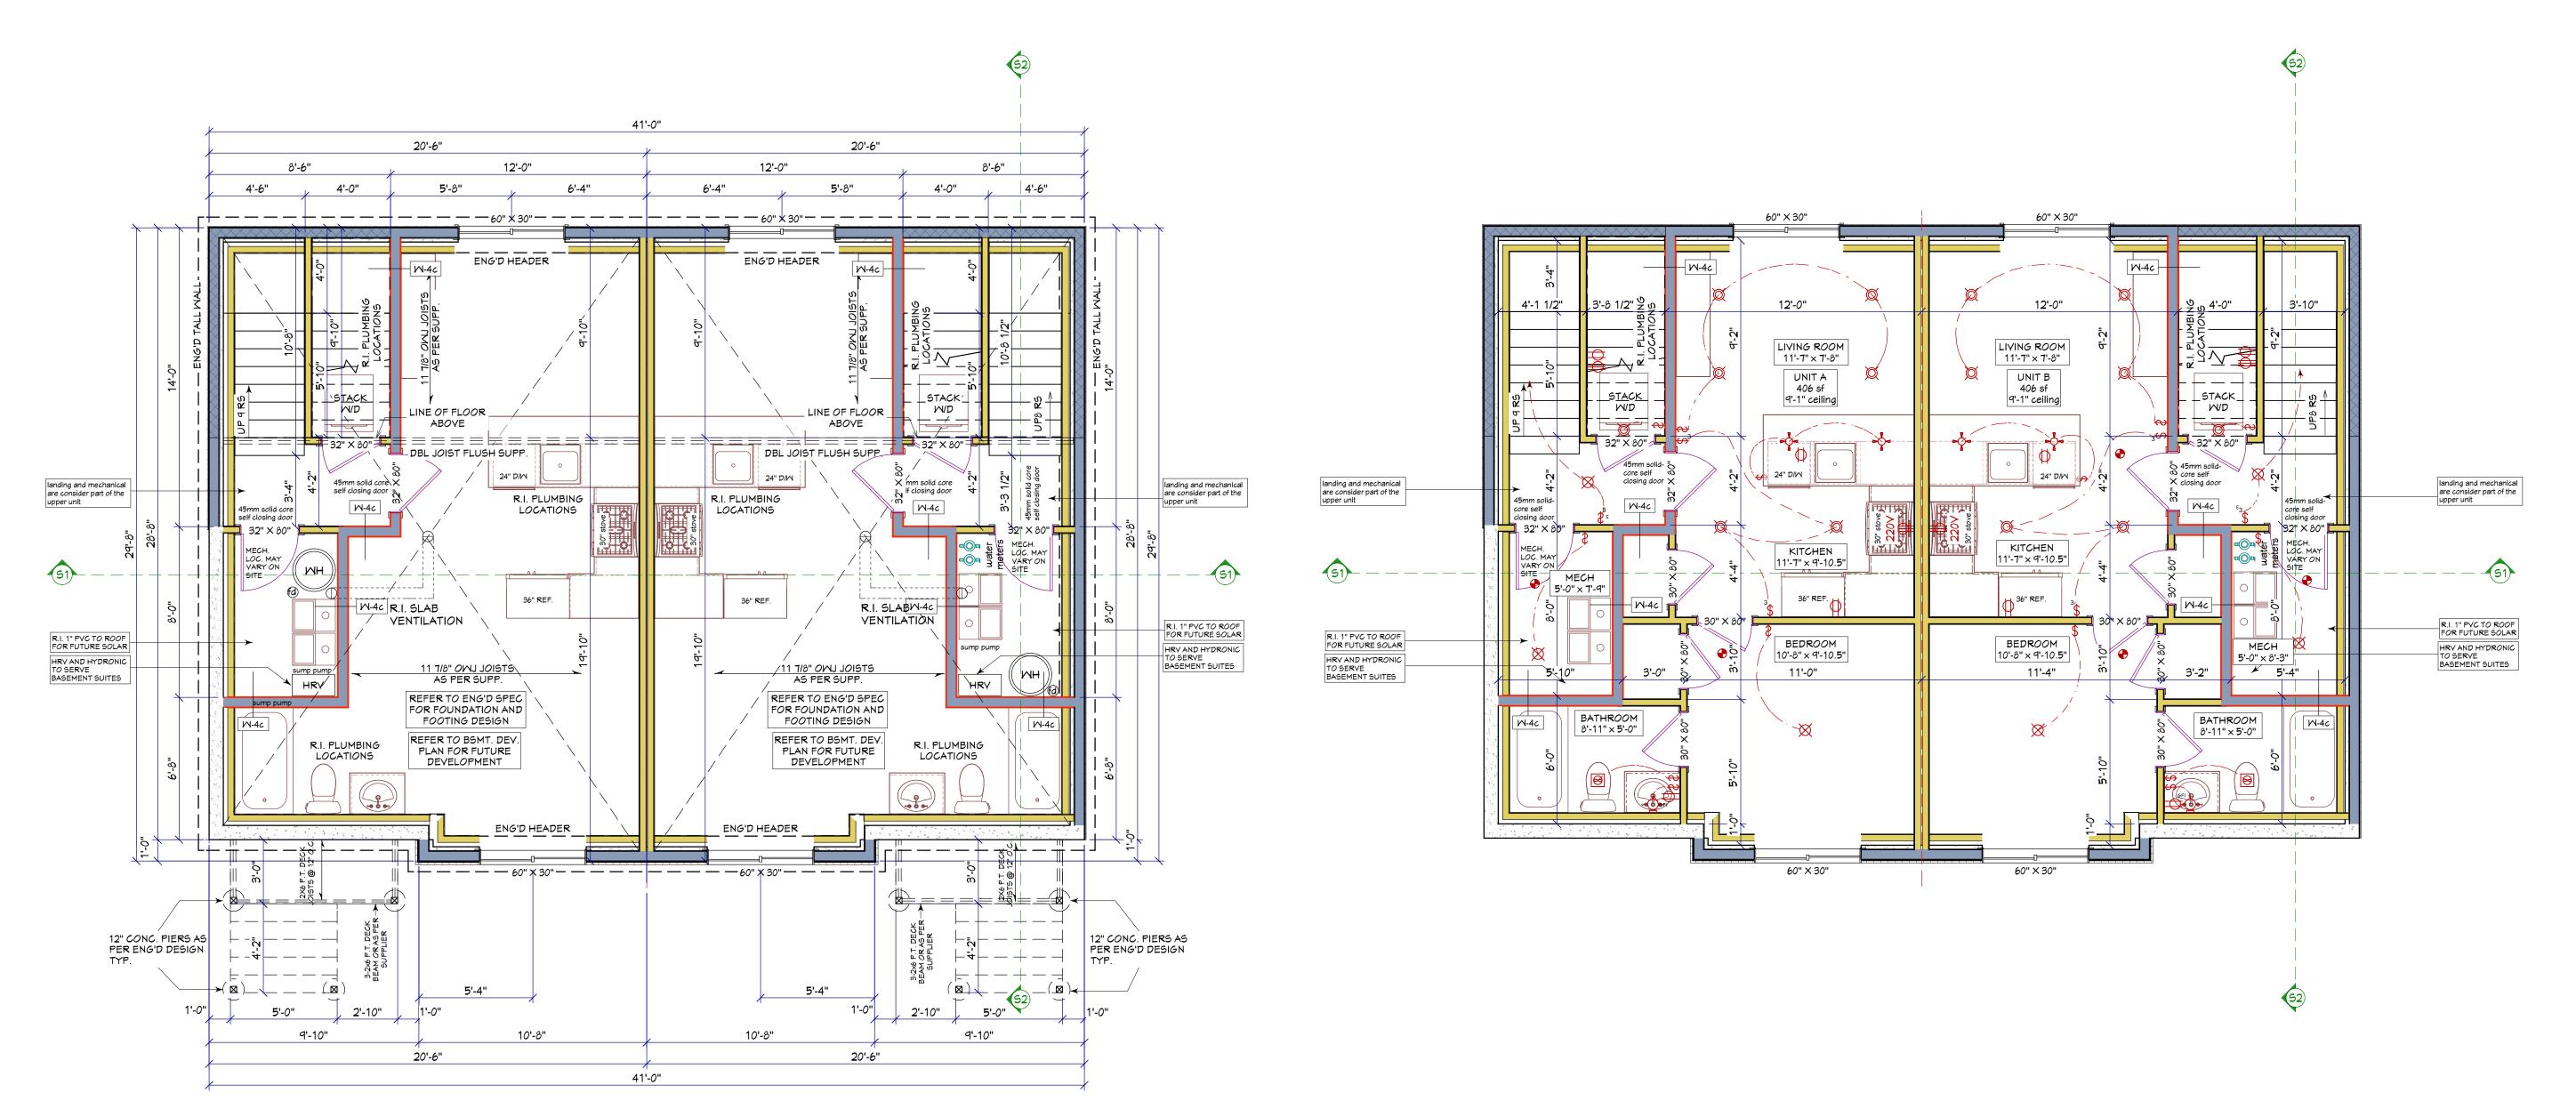

FOUNDATION PLAN BLDG 1
SCALE: 1/4" = 1'-0"

BASEMENT DEV. PLAN BLDG 1
SCALE: 1/4" = 1'-0"

### ELECTRICAL KEY

$\Diamond$	110V OUTLET	$\boxtimes$	CEILING LIGHT
Ф	210Y OUTLET		PENDANT LIGHT
<u></u>	EXHAUST FAN	<u></u>	WALL-MOUNTED LIGHT
<b></b>	CABINET UNDERMOUNT	$\bigcirc$	RECESSED POT LIGHT
•	INTERCONNECTED SMOKE ALARM & CO		EYEBALL POT LIGHT
	DETECTOR	-ф-	PUCK LIGHT
<b>⊕</b>	MOTION SENSOR LIGHT		STAIR RISER LIGHT
	FLUORESCENT	$\bigotimes_{F}$	C PULL CHAIN LIGHT

ALL CAT5, RG6, IN-HOME SPEAKER, INTERCOM, & HOME THEATRE WIRING TO BE DETERMINED WITH SUPPLIER.

SUPPLIER TO CO-ORDINATE WITH ELECTRICIAN TO ENSURE SUFFICIENT ELECTRICAL RECEPTACLES PROVIDED AT THE ABOVE LOCATIONS.

ONLY RECEPTACLES DEDICATED OR SPECIFIED BY HOMEOWNER HAVE BEEN SHOWN. ALL REMAINING RECEPTACLES TO BE LOCATED AS REQUIRED BY CURRENT ELECTRICAL CODE.

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UPPER	633
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#101 & #102 7425 20 St. SE

## LEGAL ADDRESS

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### PROJECT


OGDEN MID-BLOCK DEVELOPMENT BUILDING 1


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PROJECT#	23-3-CL-CN-036
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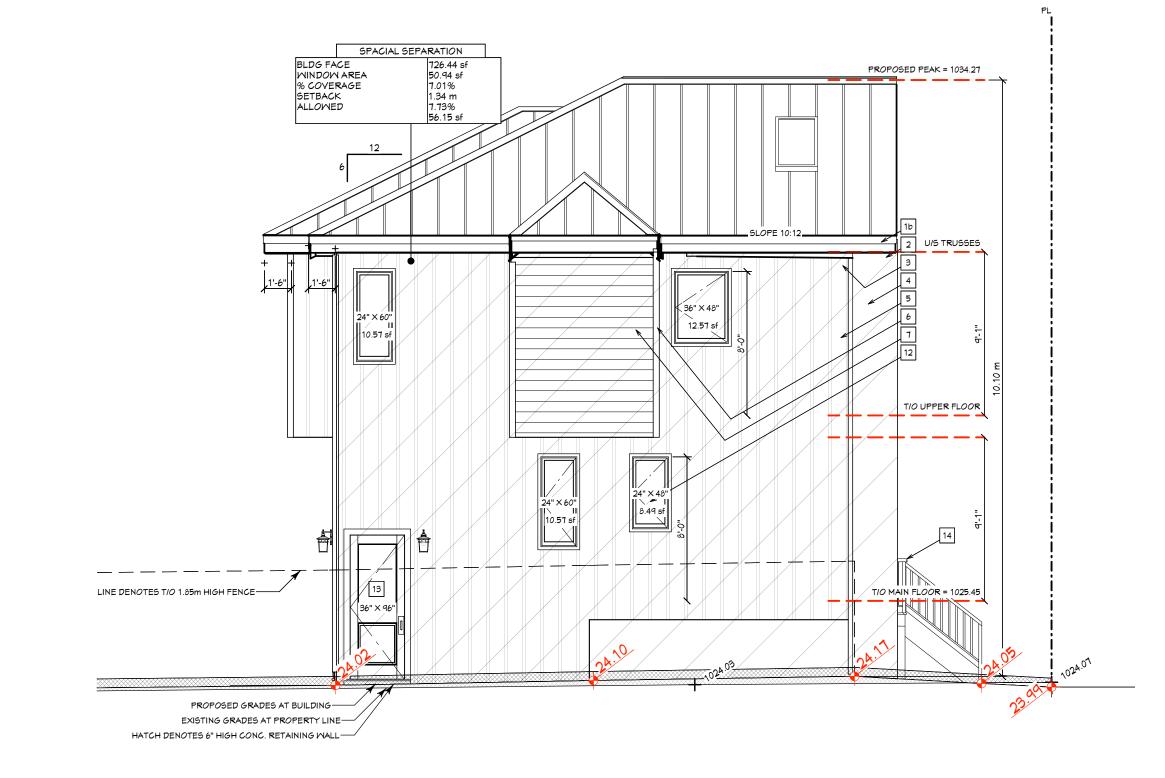
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# FOUNDATION & BASEMENT DEV. PLANS

	ZONING			R-CG
	PAGE	A4	9	
1	13:20:10 2025-06-19			






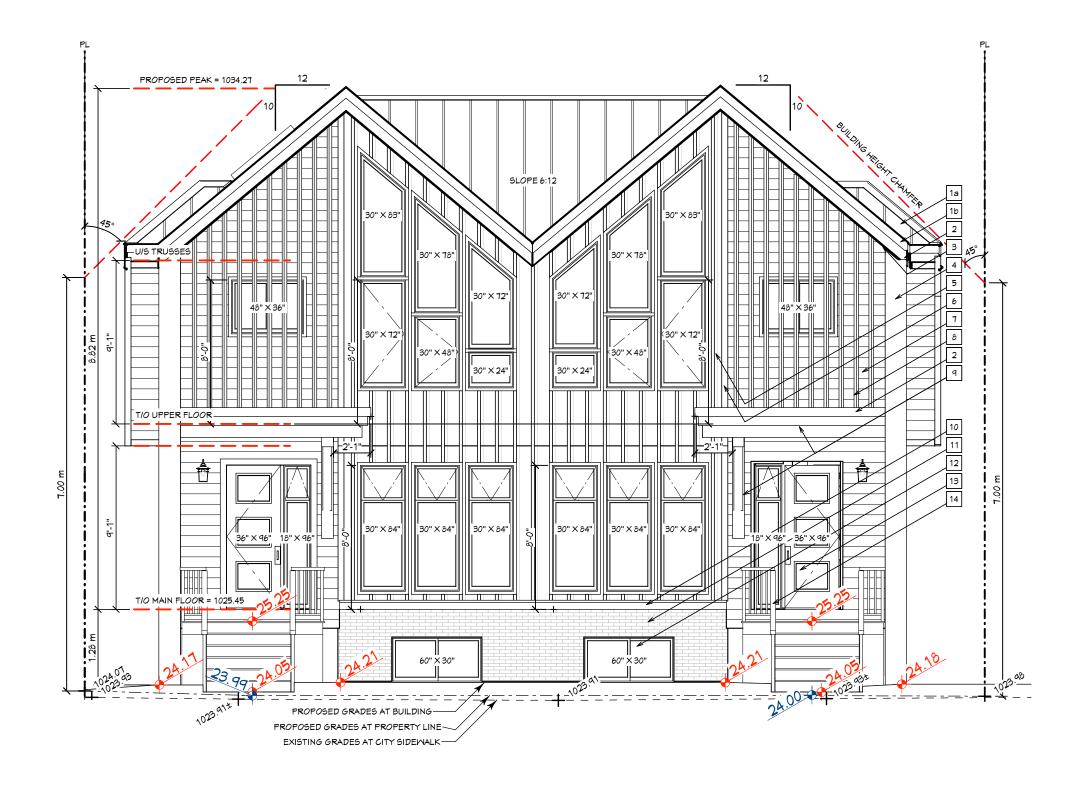
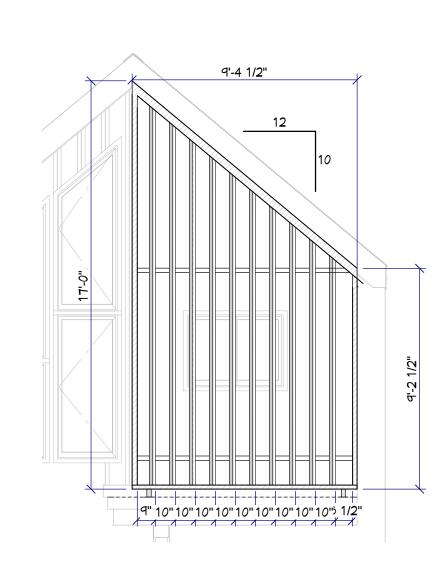
# ELEV. - EAST - BUILDING 1 FRONT

SCALE: 3/16"=1'-0"

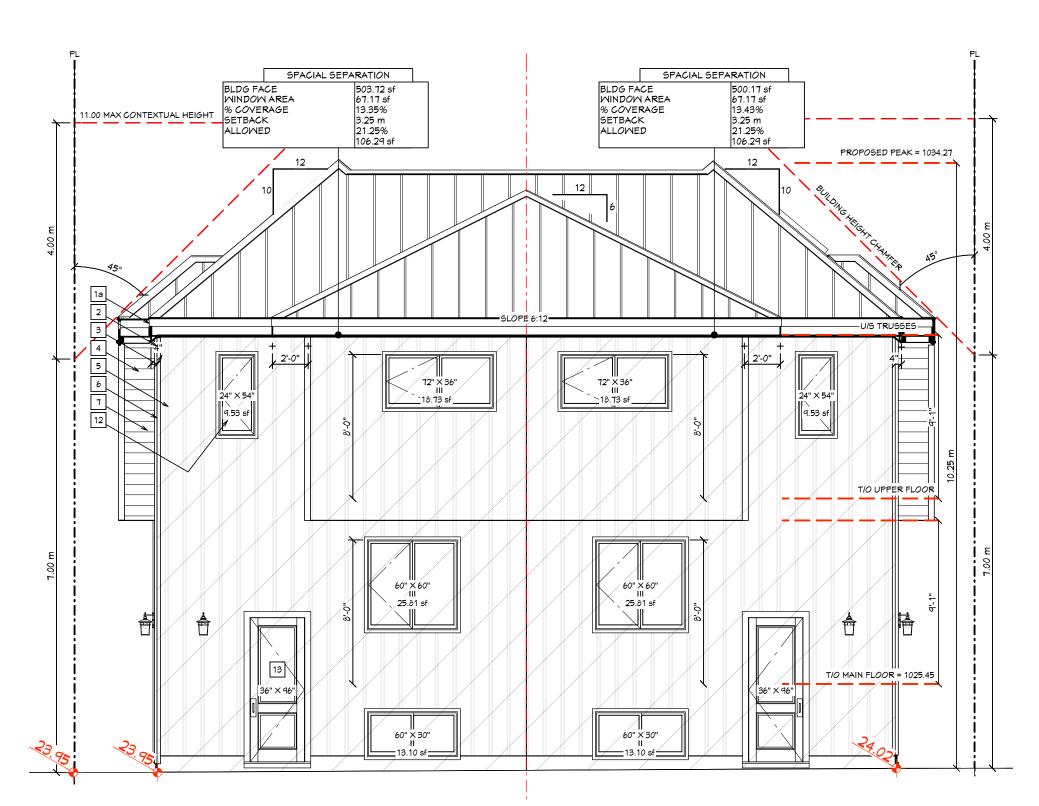


EXTERIOR CLADDING SCHEDULE 1a ASPHALT ROOFING METAL SEAM ROOFING ALUMINUM FASCIA T&G FINISHED VENTED ALUMINUM SOFFIT 4 ALUMINUM CAP VERTICAL BOARD & BATTEN 6 4" CORNER BOARD HORIZONTAL SIDING ALUMINUM VERTICAL FINS W. TIMBER FINISH 9 P.T. TIMBER BEAM/BRACKETS STONE CAP 1 STONE VENEER 12 YINYL CLAD MINDOMS FIBREGLASS DOOR 14 RAILING 15 STEEL GARAGE DOOR

ELEV - LOUVRES ENLARGED VIEW

SCALE: 1/4"=1'-0"

ELEV. - SOUTH SCALE: 3/16"=1'-0"

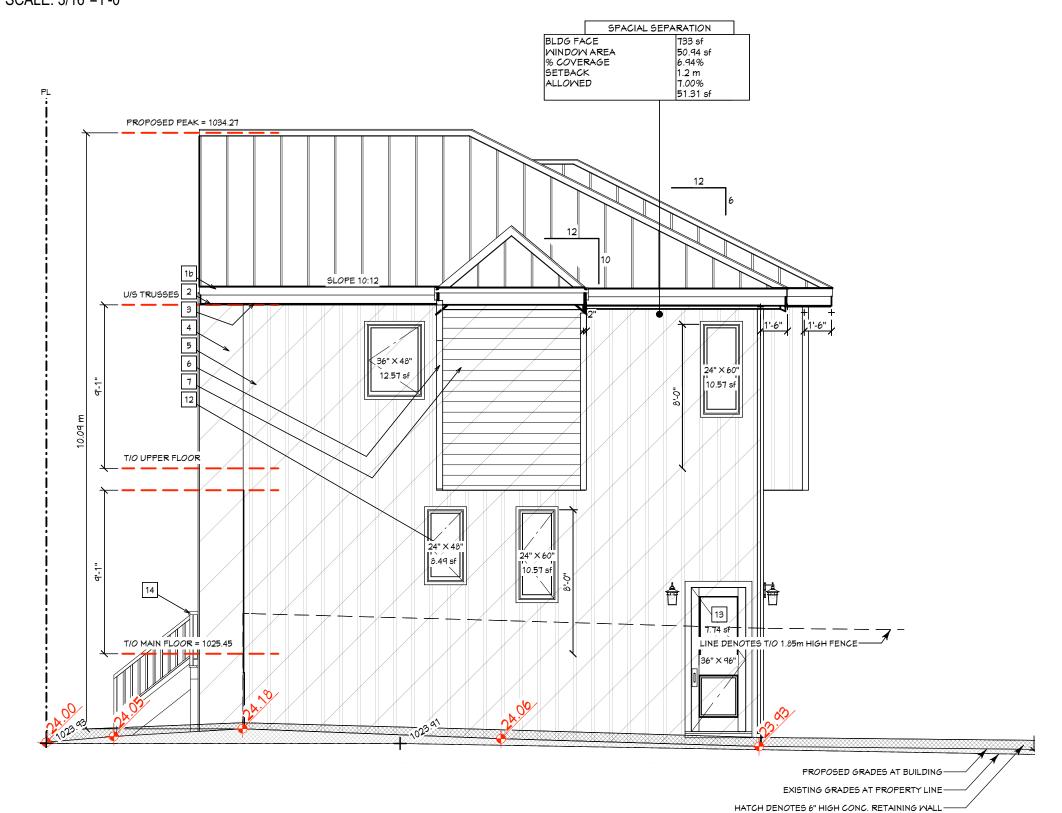

ELEV. - NORTH SCALE: 3/16"=1'-0"

**RESPONSIBILITIES** 

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info@newcenturydesign.ca

	m/d/y
Design Draft	06.03.24
DP Submission	06.27.24
DTR Submission	10.09.24
DSSP Grade Updates	12.12.24
Pricing Set	01.17.25
Pricing Set - Detail Update	03.28.25
BP Set	04.24.25
BP Set 1.01	06.19.25

AREAS		
TOTAL GROSS FLOC	R AREA	S.F.
#102 7425 UNIT A1	TOTAL	1243
MAIN		598
UPPER		645
#102B SUITE	A2	404
#101 7425 UNIT B1	TOTAL	1243
MAIN		598
UPPER		645
#101B SUITE	B2	404
#202 7425 UNIT C1	TOTAL	1221
MAIN		588
UPPER		633
#202B SUITE	C2	395
#201 7425 UNIT D1	TOTAL	1221
MAIN		588
UPPER		633
#201B SUITE	D2	395

STREET ADDRESS

#101 & #102 7425 20 St. SE

LEGAL ADDRESS

LOTS 12 & 13, BLOCK 8, PLAN 955AV

PROJECT

OGDEN MID-BLOCK DEVELOPMENT

**BUILDING 1** CHECKED: DK DESIGN/DRAWN: DK PROJECT# 23-3-CL-CN-036


SCALE AS SHOWN


TITLE

**ELEVATIONS** 

ZONING		R-CG
PAGE	^ _	
	A5	



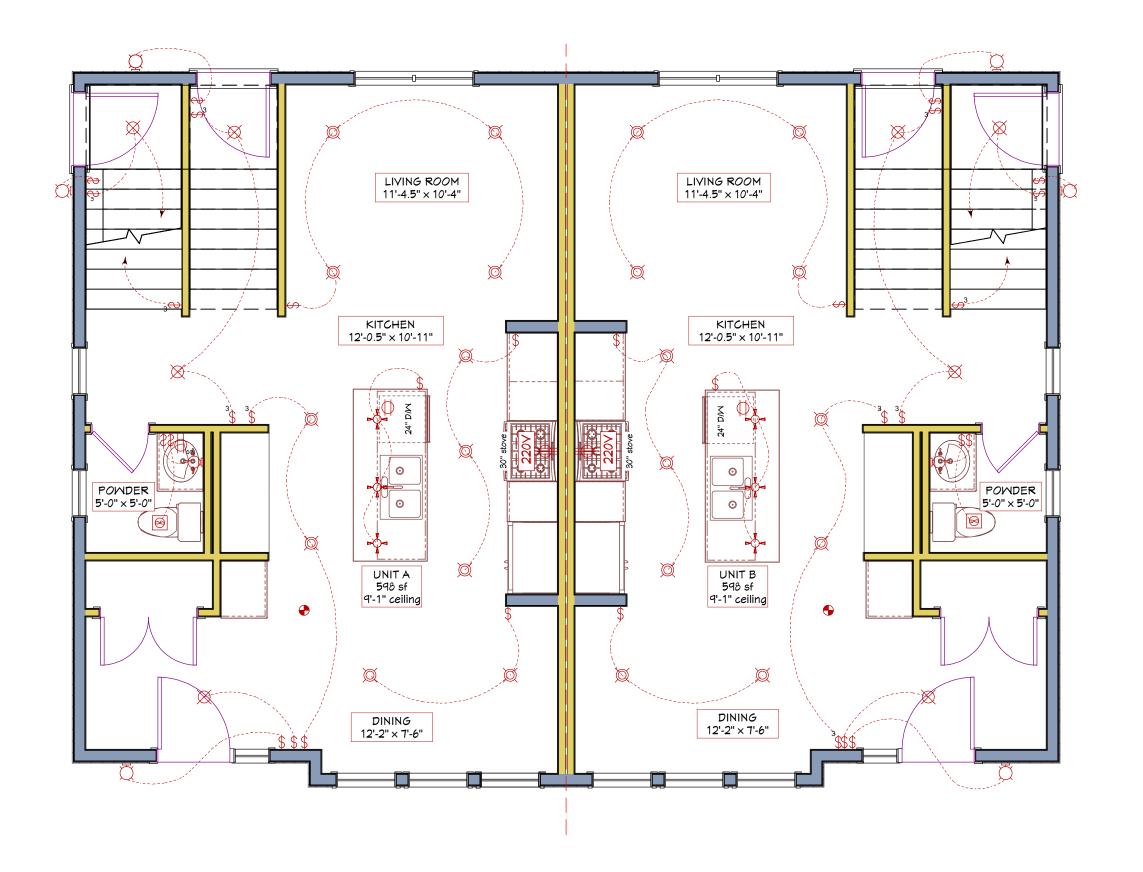

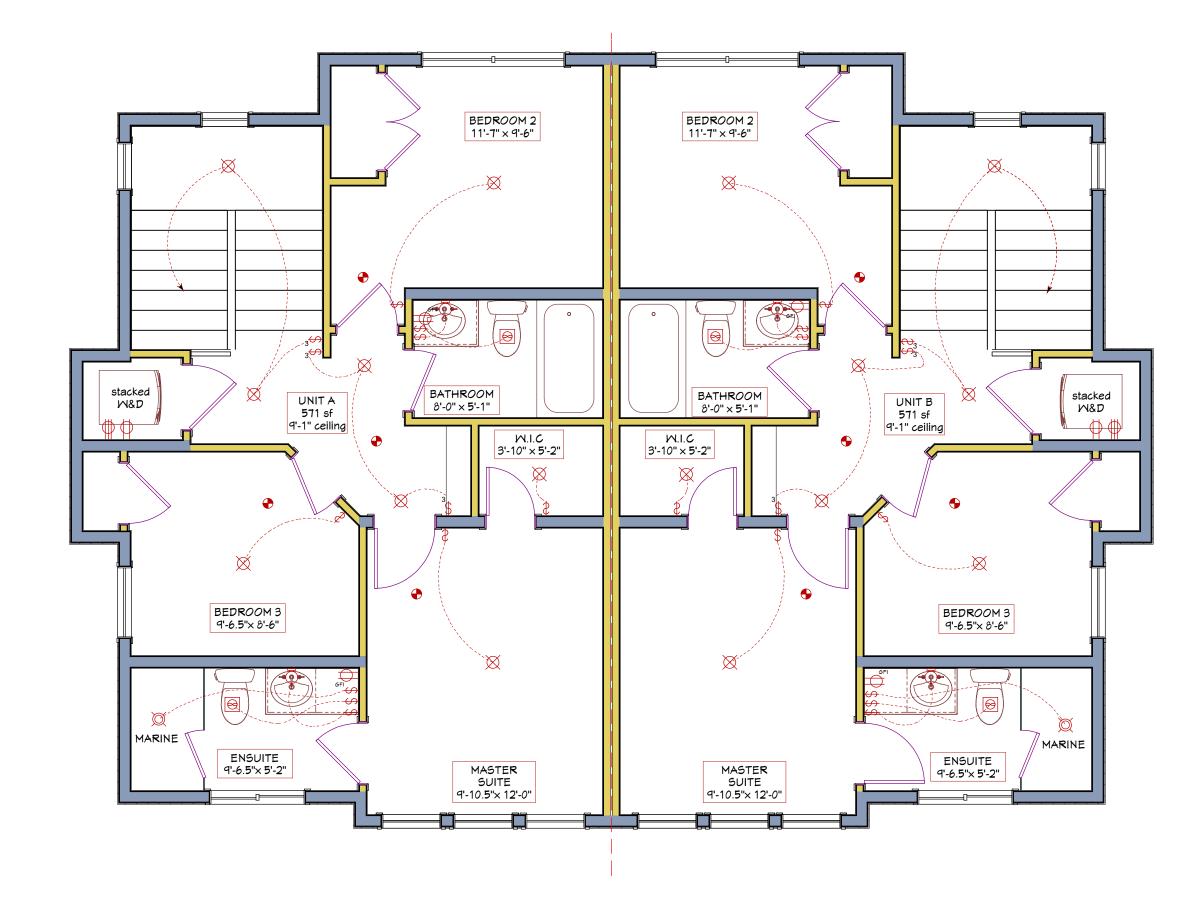

MAIN FLOOR ELECTRICAL BLDG 1 SCALE: 3/16" = 1'-0"

UPPER FLOOR ELECTRICAL BLDG 1 SCALE: 3/16" = 1'-0"

# ELECTRICAL KEY

$\Diamond$	110V OUTLET	CEILING LIGHT
$\Diamond$	210V OUTLET	PENDANT LIGHT
	EXHAUST FAN	- WALL-MOUNTED LIGHT
<b></b>	d CABINET UNDERMOUNT	RECESSED POT LIGHT
•	INTERCONNECTED SMOKE ALARM & CO	- EYEBALL POT LIGHT
	DETECTOR	
<b>-</b>	MOTION SENSOR LIGHT	△ STAIR RISER LIGHT
	FLUORESCENT	XPC PULL CHAIN LIGHT

ALL CAT5, RG6, IN-HOME SPEAKER, INTERCOM, & HOME THEATRE WIRING TO BE DETERMINED WITH SUPPLIER.

SUPPLIER TO CO-ORDINATE WITH ELECTRICIAN TO ENSURE SUFFICIENT ELECTRICAL RECEPTACLES PROVIDED AT THE ABOVE LOCATIONS.

ONLY RECEPTACLES DEDICATED OR SPECIFIED BY HOMEOWNER HAVE BEEN SHOWN. ALL REMAINING RECEPTACLES TO BE LOCATED AS REQUIRED BY CURRENT ELECTRICAL CODE.

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# ISSUED / REVISED

	m/d/y
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BP Set	04.24.25
BP Set 1.01	06.19.25

### AREAS

OR AREA	S.F
TOTAL	1243
	598
	645
A2	404
TOTAL	1243
	598
	645
B2	404
TOTAL	122′
	588
	633
C2	398
TOTAL	122
	588
	633
D2	395
	TOTAL  E A2  TOTAL  E B2  TOTAL  E C2  TOTAL

# STREET ADDRESS

#101 & #102 7425 20 St. SE

# LEGAL ADDRESS

LOTS 12 & 13, BLOCK 8, PLAN 955AV

### PROJECT

OGDEN MID-BLOCK DEVELOPMENT **BUILDING 1** 

CHECKED: DK DESIGN/DRAWN: DK PROJECT# 23-3-CL-CN-036 SCALE 3/16" = 1'-0"

TITLE

13:20:11 2025-06-19

ELECTRICAL PLANS

ZONING R-CG PAGE

# CONSTRUCTION NOTES KEY

ALL Rsi VALUES AS PER NBC:AE2023 A-9.36.2.4.(1)D. UNLESS NOTED OTHERWISE

HEAT RECOVERY VENTILATION SYSTEM TO BE INSTALLED AS PER NBC:AE2023 9.36.3.9 AND 9.36.3.10 REQUIREMENTS.

ROOF, WALL, AND FLOOR ASSEMBLIES TO MEET OR EXCEED NBC:AE2023 CODE MINIMUMS OUTLINED IN NBC:AE2023 9.36.2.6.B. AND 9.36.2.8.B.

WINDOWS, DOORS, AND SKYLIGHTS TO MEET OR EXCEED NBC:AE2023 CODE MINIMUMS OUTLINED IN NBC:AE2023 9.36.2.7.A. AND 9.36.2.7.B. REFER TO MANUF. OR SUPPLIER WINDOW ORDER FOR SPECIFIC U-VALUES.

### FRAMED ROOF (Rsi value)

• EXTERIOR AIR FILM (0.03) EXTERIOR ROOFING AS PER SPEC BUILDING PAPER • 3/8" OSB SHEATHING WITH 'H' CLIPS • APPROVED WOOD TRUSSES @ 24" O.C. WITH RAISED HEEL AS PER ROOF SUPPLIER LAYOUT • 16-1/2" LOOSE FILL GLASS FIBRE INSULATION (R44) 3-1/2" LOOSE FILL GLASS FIBRE INSULATION (R9.5) (Rsi(c)) OVERALL 20" INSULATION • 6mil POLY VAPOUR BARRIER • 1/2" GYPSUM BOARD CEILING (80.0) INTERIOR AIR FILM (0.11)

Rsi(f) 0.76 at 7% Rsi(c) = 1.67 at 93%

Rsi(parallel) = 100 / ((7/0.76) + (93/1.67)) = 1.54Total Effective Rsi Value =

Rsi VALUE AT EAVES TO BE MIN. 3.52.

### EXTERIOR WALLS (Rsi value)

• EXTERIOR AIR FILM EXTERIOR CLADDING AS PER SPEC BUILDING PAPER 3/8" OSB SHEATHING • 2X6 #2 SPR STUDS @ 24" O.C • 5-1/2" BATT INSULATION (R22) (Rsi(c)) 6mil POLY VAPOUR BARRIER • 1/2" GYPSUM BOARD (80.0)INTERIOR AIR FILM

Rsi(f) = 1.19 at 20% Rsi(c) = 3.87 at 80%Rsi(parallel) = 100 / ((20/1.19) + (80/3.87)) = 2.67

Total Effective Rsi Value =

### FOUNDATION WALLS (Rsi value)

2.99

• 8" CONCRETE FOUNDATION WALL C/W 2X6 LADDER SILL & 3 ROWS 2-10m BARS TOP, MID, & BOTTOM (refer to eng'd spec) (80.0)• 20X8" CONC. FOOTING C/W 2-SINGLE ROWS 10m BARS • 1" AIR GAP • 2X4 FURRED WALL OFFSET 2" @ 24" O.C. (Rsi(f)) 2" BATT INSULATION 3-1/2" BATT INSULATION OVERALL 5-1/2" INSULATION (R22) • 6mil POLY VAPOUR BARRIER • 1/2" GYPSUM BOARD INTERIOR AIR FILM (0.12)Rsi(f) = 0.76 at 20% Rsi(c) = 2.46 at 80% Rsi(parallel) = 100 / ( (20/0.76 + (80/2.46) ) = 1.70 Total Effective Rsi Value =

### FROST WALLS

• 8" CONCRETE FOUNDATION WALL C/W 2X6 LADDER SILL & 3 ROWS 2-10m BARS TOP, MID, & BOTTOM (refer to eng'd spec) • 20X8" CONC. FOOTING C/W 2 SINGLE ROWS 10m BARS MIN. 48" BELOW GRADE

• 2-LAYERS 5/8" TYPE-X GYPSUM BOARD

### W-3a PARTY WALL (FRAMED) 1hr FRR

• 5/8" TYPE-X GYPSUM BOARD • 2X4 #2 SPR STUDS @ 16" O.C. WITH 4" ABSORBATIVE MATERIAL • 2X4 #2 SPR STUDS @ 16" O.C. STAGGERED

AS PER NBC:AE2023 A-9.10.3.1.A. Wall W14c: FRR RATING 1h, TYPICAL STC 57

## INTERIOR LOAD-BEARING WALLS

• 1/2" GYPSUM BOARD • 2X4, 2-2X4, 2X6, 2-2X6, 2X8 #2 SPR STUDS @ 16" O.C. AS NOTED ON FLOORPLAN, UNLESS ENG'D

# INTERIOR PARTITION WALLS

• 1/2" GYPSUM BOARD • 2X4, 2-2X4, 2X6, 2-2X6, 2X8 #2 SPR STUDS @ 16" O.C AS NOTED ON FLOORPLAN • 1/2" GYPSUM BOARD

# W-4c SEPARATION WALLS

• 1/2" GYPSUM BOARD • 2X6 #2 SPR STUDS @ 16" O.C. R20 BATT INSULATION 6mil POLY VAPOUR BARRIER

• 1/2" GYPSUM BOARD

• 1/2" TYPE-X GYPSUM BOARD • TAPE AND SEAL ALL JOINTS TO BE GAS IMPERMEABLE

## FRAMED FLOOR

• FINISH AS PER SPEC • 3/4" T&G OSB SUBFLOOR, NAILED, SCREWED, GLUED • ENG'D FLOOR JOISTS SIZE, SPACING, AND LOCATION AS PER FLOOR SUPPLIER LAYOUT • 1/2" GYPSUM BOARD CEILING WHERE APPLICABLE

### FRAMED FLOOR OVER UNCONDITIONED **SPACE**

si value) • INTERIOR AIR FILM (0.16)• FINISH AS PER SPEC • 3/4" T&G OSB SUBFLOOR, NAILED, SCREWED, GLUED (0.19)• ENG'D FLOOR JOISTS SIZE, SPACING, AND LOCATION AS PER FLOOR SUPPLIER LAYOUT • 6"+ 2lb SPRAY FOAM INSULATION (R31)

 VENTED SOFFIT Rsi (f) = 2.58 at 9% (I-JOISTS @ 16" O.C.) Rsi (c) = 5.47 at 91% Rsi(parallel) = 100 / ((9/2.58) + (91/5.47)) = 4.97Total Effective Rsi Value =

• 6mil POLY VAPOUR BARRIER

• 6mil POLY VAPOUR BARRIER

VENTED SOFFIT

Rsi (f) = 2.58 at 7.5% (I-JOISTS @ 19.2" O.C.) Rsi (c) = 5.47 at 92.5% Rsi(parallel) = 100 / ( (7.5/2.58) + (92.5/5.47) ) = 5.05 Total Effective Rsi Value =

\_\_\_\_ OR \_\_\_\_ • INTERIOR AIR FILM FINISH AS PER SPEC • 3/4" T&G OSB SUBFLOOR, NAILED, SCREWED, GLUED (0.19)• ENG'D FLOOR JOISTS SIZE, SPACING, AND LOCATION AS PER FLOOR SUPPLIER LAYOUT • 12" BATT INSULATION (R40) (Rsi(c))

Rsi (f) = 2.58 at 9% (I-JOISTS @ 16" O.C.) Rsi (c) = 7.04 at 91% Rsi(parallel) = 100 / ((9/2.58) + (91/7.04)) = 6.09Total Effective Rsi Value =

Rsi (f) = 2.58 at 7.5% (I-JOISTS @ 19.2" O.C.) Rsi (c) = 7.04 at 92.5% Rsi(parallel) = 100 / ((7.5/2.58) + (92.5/7.04)) = 6.23Total Effective Rsi Value =

## FLOOR SEPERATION AT SUITES

• FINISH AS PER SPEC • 3/4" T&G OSB SUBFLOOR, NAILED, SCREWED, GLUED • ENG'D FLOOR JOISTS SIZE, SPACING, AND LOCATION AS PER FLOOR SUPPLIER LAYOUT ABSORPTIVE MATERIAL IN JOIST CAVITY NOT LESS THAN 150MM IN NOMINAL THICKNESS • RESILIENT CHANNELS SPACED @ 600mm O.C. • 1/2" GYPSUM BOARD

• TAPE & MUD BOARD FOR AIR TIGHT SMOKE BARRIER AS PER NBC:AE2023 A-9.10.3.1.B. Floor F8I: FRR RATING < 30m,

### <u>F-2a</u> **CONCRETE SLAB**

STC 48, TYPICAL IIC 42

 INTERIOR AIR FILM • 4" CONCRETE SLAB min. 20 MPa WITH 10M REBAR E/W @ 24" O.C. UNLESS ENG'D. REFER TO SLAB VENTILATION DETAIL LOCATED MIN. 4'-0" BELOW FINISH GRADE 6mil POLY VAPOUR BARRIER · DAMPROOFING AS REQ'D 6" COMPACTED GRAVEL

# F-2b CONCRETE SLAB (HEATED) (Rsi value)

INTERIOR AIR FILM

" CONCRETE SLAB min. 20 MPa WITH 10M REBAR E/W @ 24" O.C. UNLESS ENG'D. REFER TO SLAB VENTILATION DETAIL RADIANT SLAB HEATING LAYOUT TO MECH. ENG'D SPEC

10 mil POLY VAPOUR BARRIER

" CONTINUOUS EXPANDED POLYSTYRENE INSULATION (R16) TO BE CONFIRMED BY MECH. ENG.

" COMPACTED GRAVEL Total Effective Rsi Value =

AMPROOFING AS REQ'D

# FRAMING HEADER NOTES

FRAMERS - 2x10 HEADERS Provide minimum 2-2X10 #2SPF Headers & Lintels in load bearing openings not to exceed: EXTERIOR WALLS 2.39m (94") Roof only. 1.96m (76") Roof & One Floor INTERIOR WALLS 1.92m (74") Roof only 1.35m (53") Roof & One Floor

FRAMERS - 2x8 HEADERS Provide minimum 2-2X8 #2 SPF Headers & Lintels in load bearing openings not to exceed: EXTERIOR WALLS 1.95m (76") Roof only. 1.61m (64") Roof & One Floor INTERIOR WALLS 1.58m (62") Roof only 1.12m (44") Roof & One Floor

For Areas where snow load does not exceed 1.5 kPa (Calgary, Cochrane, HighRiver, Okotoks, Airdrie, Strathmore)

ROOF & FLOOR SYSTEM SUPPLIER Confirm Loading and required lintel & header sizes under all girder ends, beam and flush supports. Provide size and design for any headers, lintels or beams exceeding above criteria.

Thermostats located as per mechanical supplier.

## **ROOF SUPPLIER NOTE**

MINIMUM HEEL HEIGHTS 4/12 OR GREATER: MIN. 8" HEEL HEIGHT MIN. 9" HEEL HEIGHT

MIN. 14" HEEL HEIGHT

### GENERAL CONSTRUCTION NOTES

CAULKING GENERAL NOTE: (refer to NBC:AE2023 9.7.4., 9.20.13.12., 9.28.1.5.)

• CAULKING SHALL BE PROVIDED WHERE REQUIRED TO PREVENT THE ENTRY OF WATER INTO THE STRUCTURE.

· CAULKING SHALL BE PROVIDED BETWEEN MASONRY, SIDING/STUCCO AND ADJACENT DOOR AND WINDOW FRAMES / TRIM, INCLUDING SILLS. • CAULKING SHALL BE PROVIDED AT VERTICAL JOINTS BETWEEN DIFFERENT CLADDING MATERIALS, UNLESS JOINT IS FLASHED, TO PREVENT ENTRY OF RAIN

WALL SHEATHING GENERAL NOTE: (refer to NBC:AE2023 9.23.16) • ENSURE A GAP OF MIN. 2mm. (3mm Best Practice) AT ALL JOINTS BETWEEN SHEETS OF WALL SHEATHING MATERIAL

FLASHING GENERAL NOTE: (refer to NBC:AE2023 9.3.3.2., 9.27.3.) • FLASHING SHALL BE INSTALLED AT EVERY HORIZONTAL JUNCTION BETWEEN TWO EXTERIOR FINISHES EXCEPT WHERE AN UPPER FINISH OVERLAPS A LOWER FINISH. • FLASHING SHOULD BE INSTALLED OVER ALL EXTERIOR WALL OPENINGS INCLUDING MECHANICAL PENETRATIONS INCLUDING VENTS, PIPES, ETC. • CIRCULAR PENETRATIONS SHOULD BE INSTALLED THROUGH BATTEN MATERIAL AND CAULKED. BATTEN MATERIAL IS THEN FLASHED.

WALL SHEATHING MEMBRANE GENERAL NOTE: (refer to NBC:AE2023 9.23.17)

• FLASHING TO HAVE A MINIMUM SLOPE OF 6% (3/4" : 12" SLOPE)

• AT LEAST ONE LAYER (2 Layers Best Practice) SHALL BE INSTALLED BENEATH SIDING, STUCCO & MASONRY VENEER. • MEMBRANE SHOULD BE INSTALLED HORIZONTALLY FROM BOTTOM UP SO SUCCESSIVE UPPER LAYERS OVERLAP LOWER LAYERS.

# GENERAL DESIGN AND DRAFTING NOTES

ENGINEERING AND STRUCTURE

• OVERLAP SHALL BE MIN. 4" (6" Best Practice)

• EXTERIOR DIMENSIONS ARE TYPICALLY SHOWN TO OUTSIDE FACE OF STRUCTURE AND CENTER OF BEAM UNLESS NOTED OTHERWISE

• ALL EXTERIOR WOOD IN CONTACT WITH THE GROUND OR CONCRETE SHALL BE PRESSURE TREATED • ENGINEERED ROOF AND FLOOR SYSTEMS TO BE INSTALLED TO MANUFACTURERS

SPECIFICATIONS • ALL BUILT-UP WOOD POSTS TO BE FULL WIDTH OF SUPPORTED MEMBER • STRUCTURAL BEAMS, POSTS, AND FOOTINGS INDICATED ARE GUIDELINES ONLY. FINAL STRUCTURAL BEAMS, POSTS, AND FOOTINGS TO BE SPECIFIED BY ENGINEER.

DOORS, WINDOWS, AND OPENINGS

• WINDOWS AND DOORS NOTED IN PLANS ARE NOMINAL DIMENSIONS. ROUGH OPENING DIMENSIONS PROVIDED BY WINDOW AND DOOR SUPPLIER. • ANY DOOR BETWEEN A GARAGE AND DWELLING TO BE SELF-CLOSING AND

WEATHERSTRIPPED AS PER NBC:AE2023 9.10.13.15. • ATTIC ACCESS TO BE WEATHERSTRIPPED AND INSULATED AS PER NBC:AE2023 9.19.1. REFER

MECHANICAL. ELECTRICAL, PLUMBING

• EXACT LOCATIONS OF MECHANICAL, ELECTRICAL, AND PLUMBING MAY VARY ON SITE • SMOKE AND CARBON MONOXIDE DETECTORS INSTALLED AS PER NBC:AE2023 9.10.18.

GENERAL CONSTRUCTION

• STEP FOOTINGS TO MAINTAIN MIN. 48" FROST COVERAGE, WHERE EACH STEP IS A MAXIMUM 24" VERTICAL RISE AND MINIMUM 24" HORIZONTAL RUN.

• HANDRAILS AND RAILING TO BE PROVIDED FOR ALL STAIRS AS PER NBC:AE2023 9.8.7. • ALL WALLS AND CEILINGS OF AN ATTACHED GARAGE TO BE TAPED, DRYWALLED, VAPOUR BARRIERED, AND INSULATED

AS PER NBC:AE2023 9.25.4., 9.34., & 9.35.4. AIR BARRIER SYSTEM TO BE INSTALLED. SEALED. AND AIRTIGHT AS PER NBC:AE2023 9.35.3. & 9.36.2.10. USING 6mil POLYETHYLENE WITH 2lb SPRAY FOAM AT JOIST ENDS AND CANTILEVERS. • VAPOUR BARRIER SYSTEM TO BE INSTALLED, SEALED, AS PER NBC:AE2023 9.25.4. USING 6mil


# POLYETHYLENE UNLESS NOTED OTHERWISE. BUILDING CODE FENESTRATION

NBC:AE2023 - Table 9.7.3.3., 9.36.2.7.A., & 9.36.2.7.B. Max. U-value for windows/doors = 1.6. Max. U-value for skylights = 2.7.


Calgary 2.5% January Design Temperature of -30 C.

Location: Calgary, AB Product Height: 10m Terrain Type: Rough

Min. Performance Grade (PG) Min. Positive Design Pressure = 1200 PA Min. Negative Design Pressure = 1200 PA Min. Water Penetration Test Pressure = 260 PA Min. Canadian air Infiltration / Exfiltration = A2

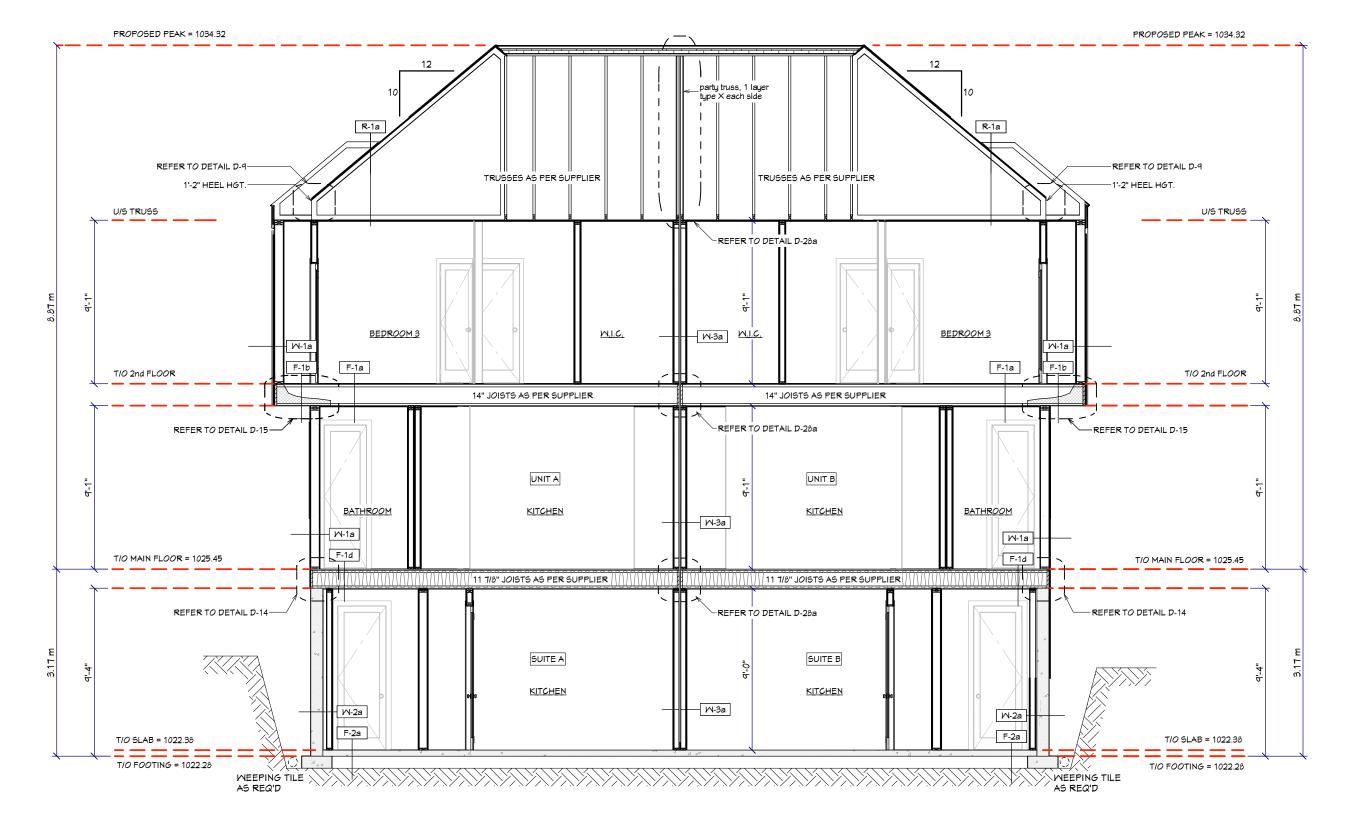

### SECTION - S1 SCALE: 3/16" = 1'-0"

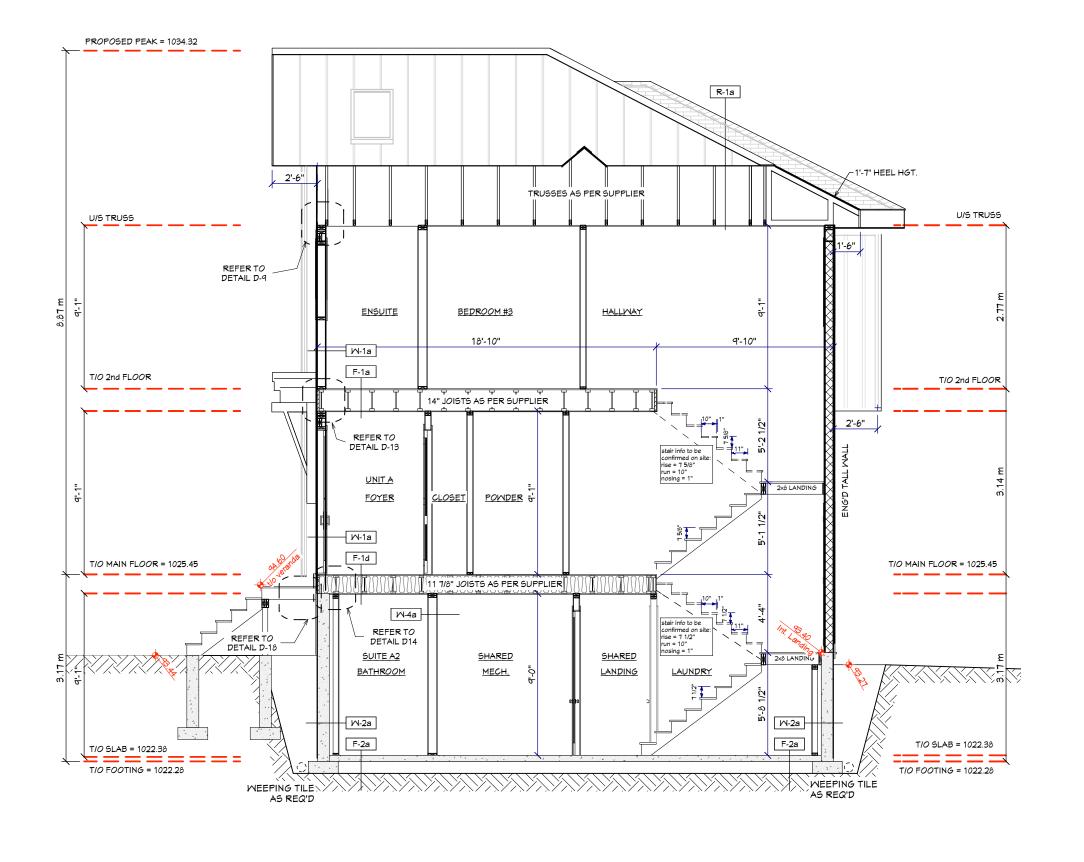

SECTION - S3 SCALE: 3/16" = 1'-0"

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06.19.25

AREAS TOTAL GROSS FLOOR AREA S.F. TOTAL #102 7425 UNIT A1 1243 MAIN 598 **UPPER** 645 #102B SUITE A2 404 TOTAL #101 7425 UNIT B1 1243 MAIN 598 **UPPER** #101B SUITE B2 404 #202 7425 UNIT C1 TOTAL 1221 MAIN 588 UPPER 633 #202B SUITE C2 395 #201 7425 UNIT D1 TOTAL 1221 MAIN 588 **UPPER** 633 #201B SUITE D2

### STREET ADDRESS

#101 & #102 7425 20 St. SE

LEGAL ADDRESS

LOTS 12 & 13, BLOCK 8, PLAN 955AV

**PROJECT** 

OGDEN MID-BLOCK DEVELOPMENT **BUILDING 1** 


CHECKED: DK DESIGN/DRAWN: DK PROJECT# 23-3-CL-CN-036 SCALE 3/16" = 1'-0"


**SECTIONS & NOTES** 

ZONING PAGE


# D-1 - TYP. EXTERIOR WALL WITH SIDING FRAMED WALL CONSTRUCTION N.T.S. SIDING AS PER SPEC STONE/BRICK AS SHEATHING AS PER CONST. NOTES CONTINUOUS WEATHER BARRIER WALL AS PER CONST. NOTES CONTINUOUS AIR/VAPOUR BARRIER WALL AS PER CO CONTINUOUS AIR/VAPOU


# D-2 - TYP. EXTERIOR WALL WITH STONE FRAMED WALL CONSTRUCTION N.T.S. STONE/BRICK AS PER SPEC METAL LATHE SHEATHING AS PER CONST. NOTES CONTINUOUS WEATHER BARRIER WALL AS PER CONST. NOTES CONTINUOUS AIR/VAPOUR BARRIER NOTE: REFER TO MANUF. INSTALATION DETAILS

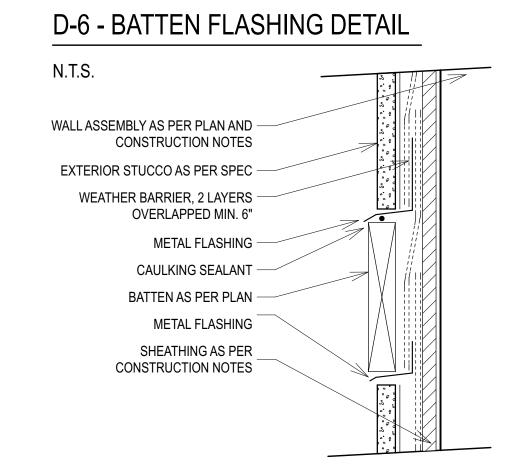

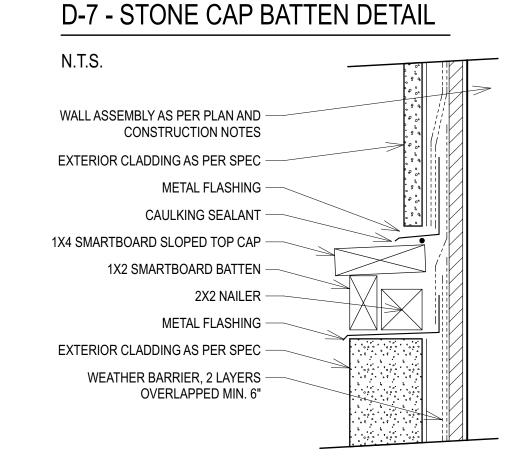



# D-9 - TYP. ROOF CONNECTION DETAIL STANDARD SLOPE (4/12 - 6/12) ROOF WITH FRAMED WALL N.T.S. ROOFING AND UNDERLAYMENT AS PER SPEC ROOF SHEATHING AS PER CONST. NOTES CARDBOARD INSULATION STOP HEEL HEIGHT AS PER SECTION ALUM. SOFFIT CLADDING AS PER SPEC INSULATION AS PER CONST. NOTES CONTINUOUS WEATHER BARRIER CONTINUOUS AIR/VAPOUR BARRIER

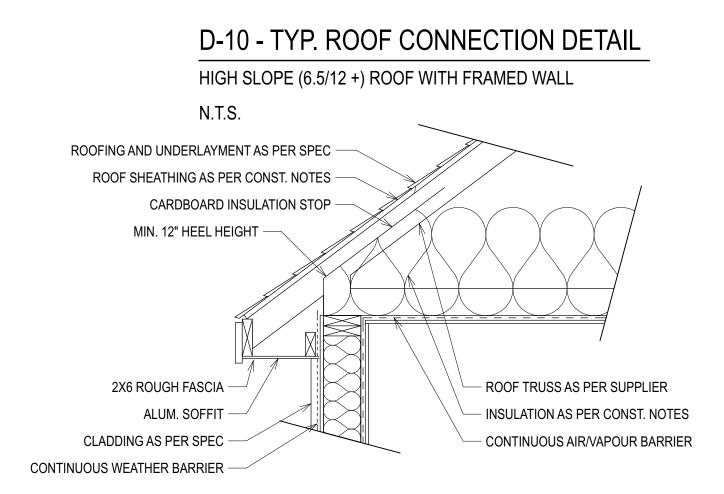


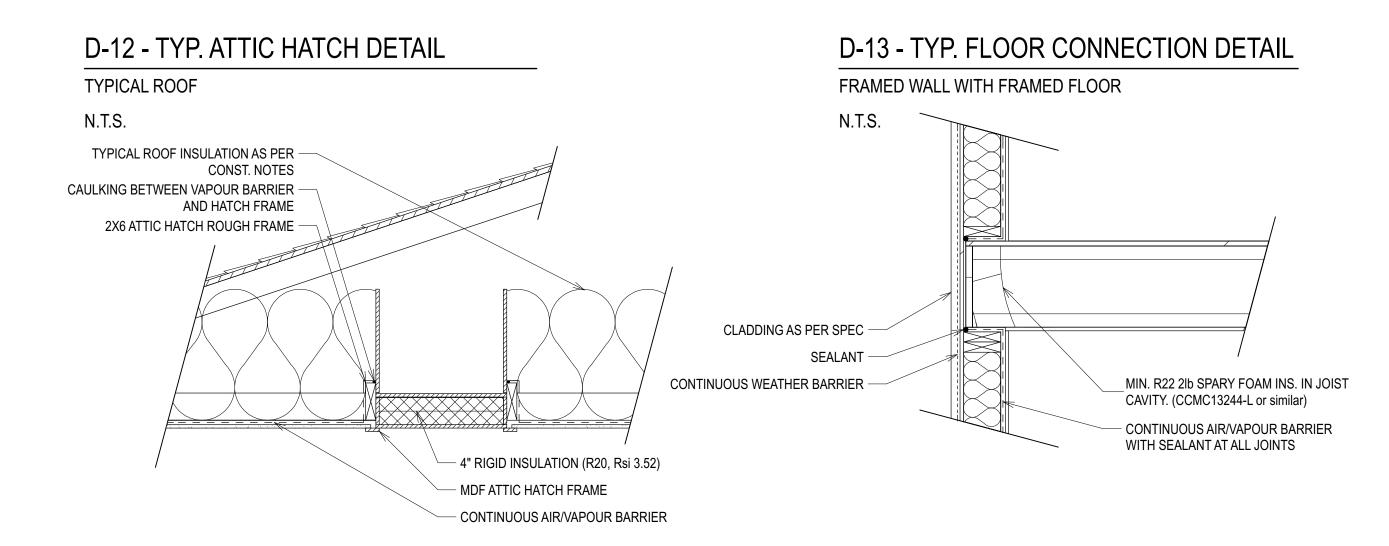

# D-14 - TYP. FOUNDATION CONNECTION DETAIL FRAMED WALL WITH FOUNDATION WALL N.T.S. CLADDING AS PER SPEC CONTINUOUS WEATHER BARRIER SEALANT 2X6 LADDER SILL FINISH GRADE MIN. R22 2lb SPARY FOAM INS. IN JOIST CAVITY. (CCMC13244-L or similar) CONTINUOUS AIR/VAPOUR BARRIER

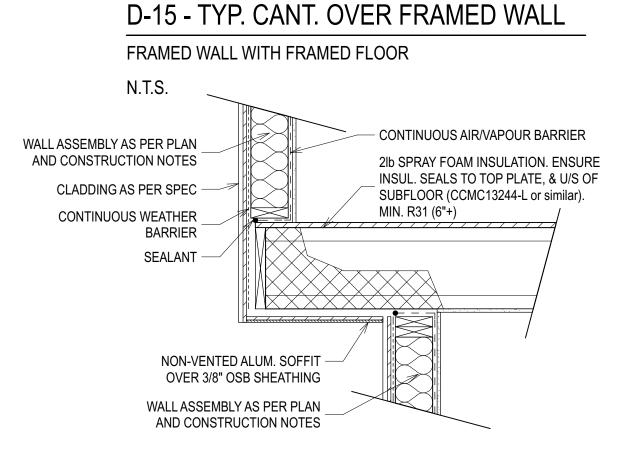

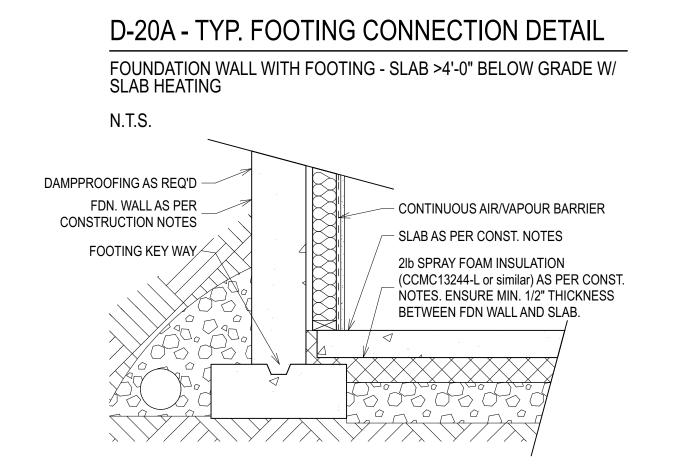

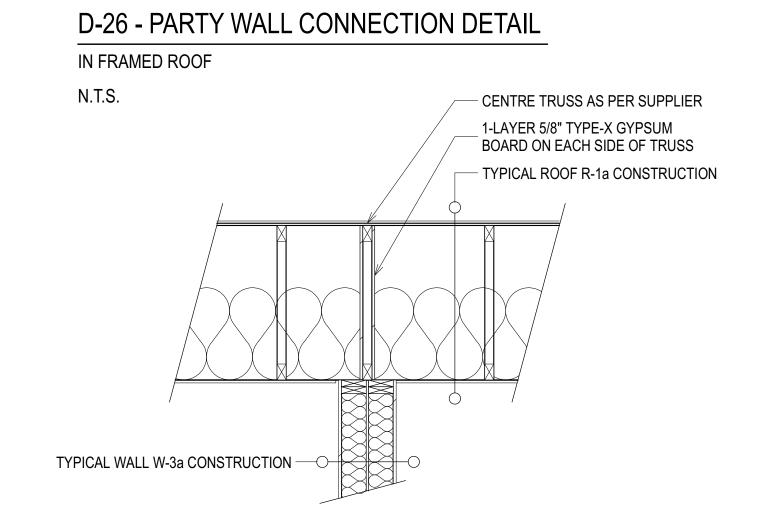

## **RESPONSIBILITIES**

### **NEW CENTURY DESIGN**

It is NCD's responsibility to ensure these drawings meet or exceed the current Provincial Building Code and Land Use Bylaws. NCD will make all revisions, additions, or corrections required due to stated code or bylaws. Changes etc, due to discretionary interpretations by Approving Authorities having jurisdiction will be at the expense of the Homeowner or General Contractor.

### ALL TRADES AND SUPPLIERS

These drawings form only PART of the construction documents. A Specification should be provided by the General Contractor (see below). Specific brands, models and trade names where used in these drawings are subject to availability and change orders, and should be confirmed in ALL cases.

THE SPECIFICATION OVERRIDES THESE DRAWINGS. NCD is

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### HOMEOWNER AND GENERAL CONTRACTOR

It is the responsibility of the Homeowner and General Contractor to review these drawings PRIOR TO START OF CONSTRUCTION. Any discrepancies between these drawings and the Specifications are to be provided in writing to New Century Design. Any errors or omissions due to items not specified by the above parties are not the responsibility of NCD.

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IS	SUED / REVISED	
		m/d/y
	Design Draft	06.03.24
	DP Submission	06.27.24
	DTR Submission	10.09.24
	DSSP Grade Updates	12.12.24
	Pricing Set	01.17.25
	Pricing Set - Detail Upo	date 03.28.25
	BP Set	04.24.25
	BP Set 1.01	06.19.25

REAS	
TOTAL GROSS FLOOR AREA	S.F.
#400 7405 LINUT A4 TOTAL	
#102 7425 UNIT A1 TOTAL	1243
MAIN	598
UPPER	645
#102B SUITE A2	404
#101 7425 UNIT B1 TOTAL	1243
MAIN	598
UPPER	645
#101B SUITE B2	404
#202 7425 UNIT C1 TOTAL	1221
MAIN	588
UPPER	633
#202B SUITE C2	395
#201 7425 UNIT D1 TOTAL	1221
MAIN	588
UPPER	633
#201B SUITE D2	395

# STREET ADDRESS

#101 & #102 7425 20 St. SE

LEGAL ADDRESS

LOTS 12 & 13, BLOCK 8, PLAN 955AV

PROJECT

OGDEN MID-BLOCK DEVELOPMENT BUILDING 1


DESIGN/DRAWN: DK CHECKED: DK
PROJECT # 23-3-CL-CN-036
SCALE

AS NOTED

TITLE


**SECTIONS & DETAILS** 


ZONING			R-C
PAGE 13:20:11 2025-06-19	A8	9	

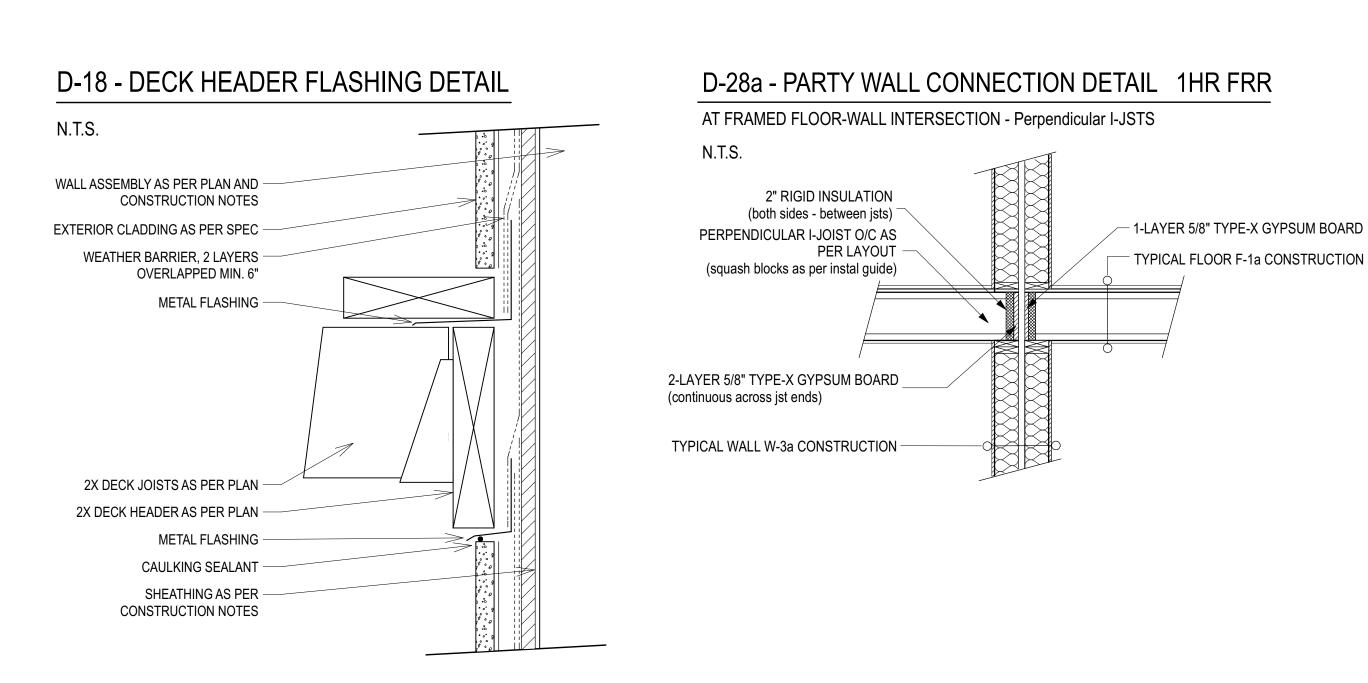


## AT EXTERIOR WALL - PLAN DETAIL N.T.S. 1" AIR GAP - FILL VOID W/ CLADDING AS PER SPEC - INSULATION FOR 12" FROM **EXTERIOR WALL** CONTINUOUS WEATHER BARRIER CONTINUE VAPOUR BARRIER 1/2" GYPSUM BOARD THROUGH STUDS AS SHOWN - 5/8" TYPE X GYPSUM BOARD ACOUSTIC SEALANT TYPICAL WALL W-3a CONSTRUCTION — —


D-28c - PARTY WALL CONNECTION DETAIL 1HR FRR

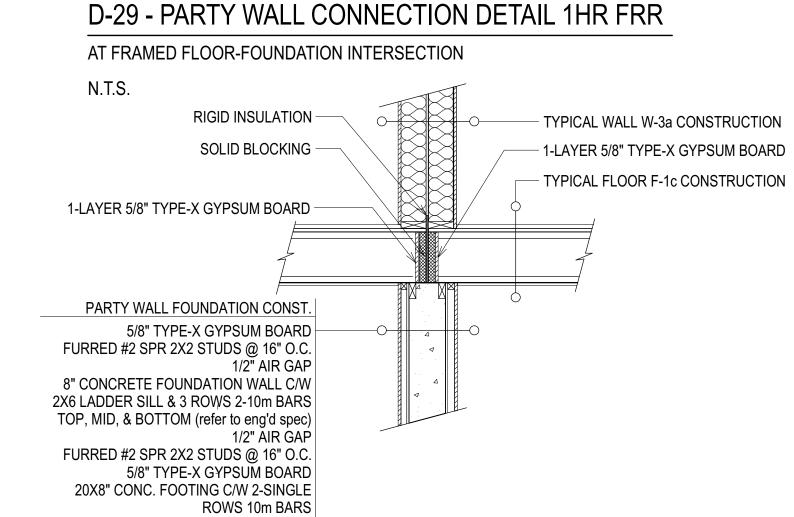

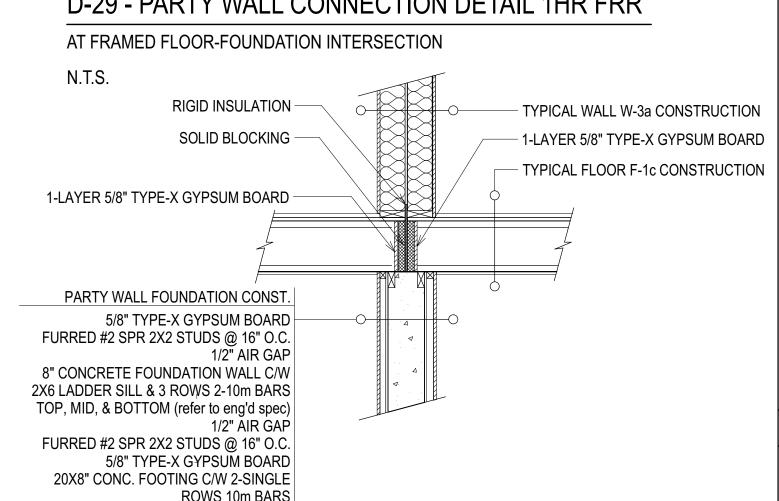



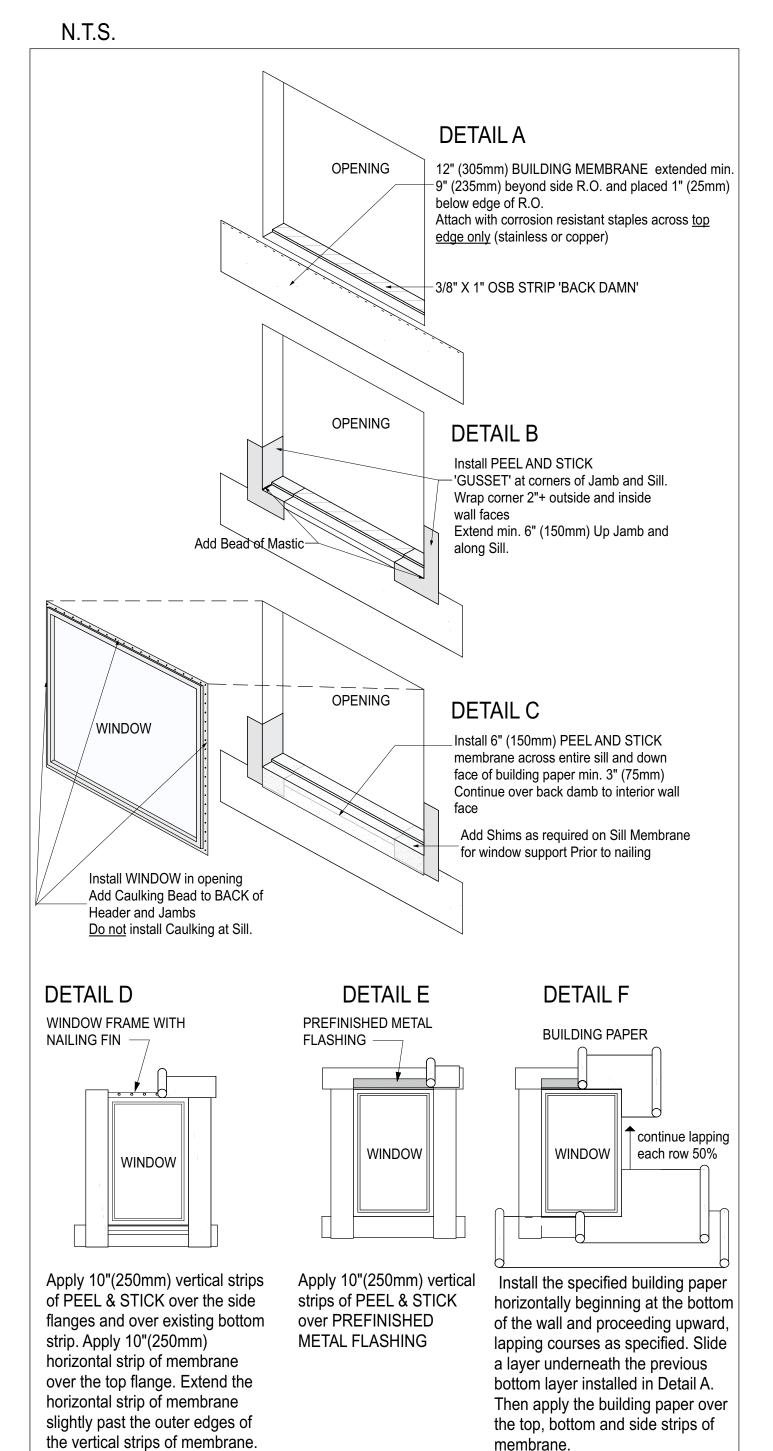


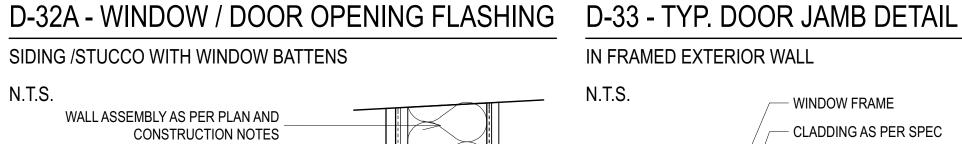


EXTERIOR CLADDING AS PER SPEC

CONTINUOUS AIR/VAPOUR BARRIER

STEP 1

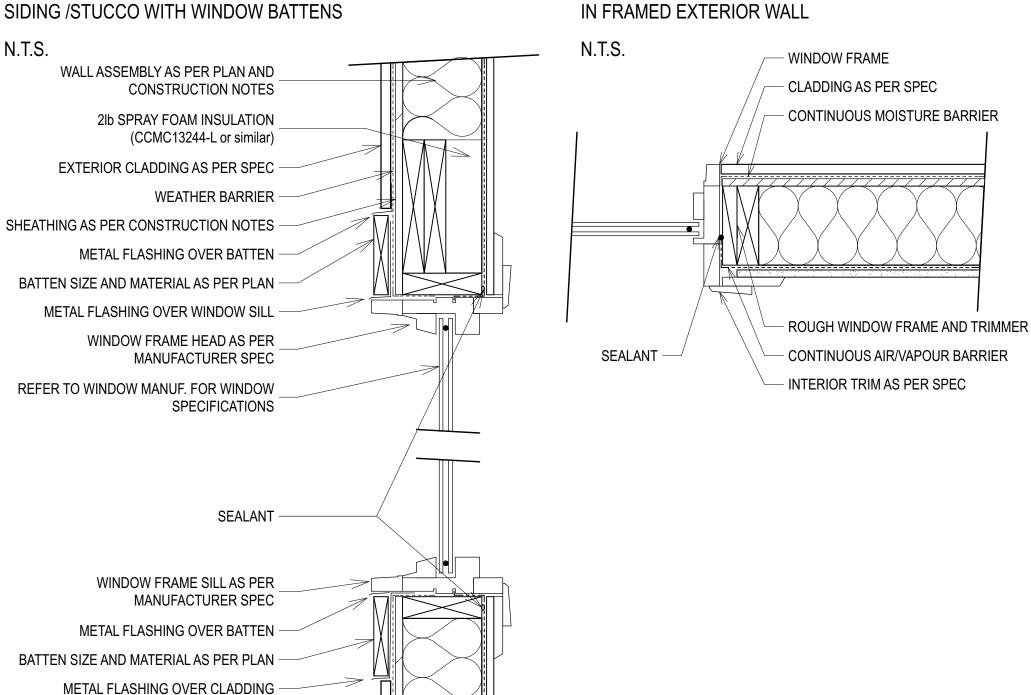

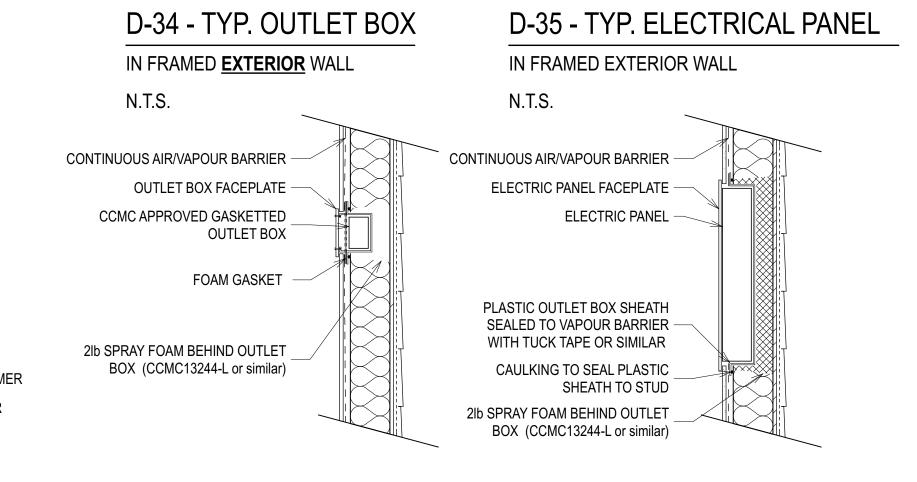


### D-37 - FLASHING END DAM DETAIL N.T.S. DO NOT CRIMPT BACK. FOLD TIGHT SO POSITIVE -SLOPE IS MAINTAINED FOLD UP EDGE STEP 2 -FOLDED SAFETY EDGE 10mm MIN. (25mm RECOMMENDED) END DAM MUST -DO NOT CUT HERE -EXTEND TO FACE OF CLADDING

NOTCH OUT FRONT FACE 25mm

FOLD CORNER FOR SAFETY EDGE

STEP 3

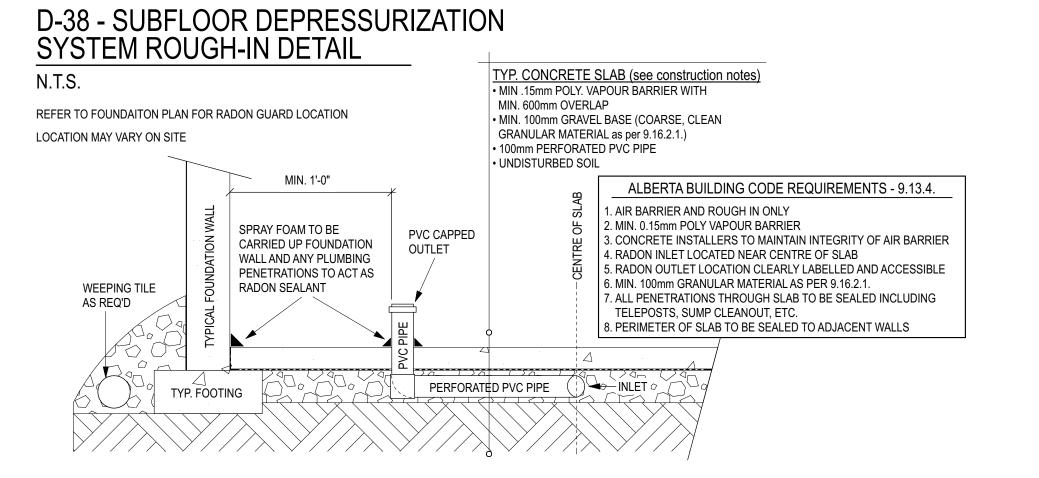

**RESPONSIBILITIES** 

**NEW CENTURY DESIGN** 

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	DSSP Grade Updates	12.12.24
	Pricing Set	01.17.25
	Pricing Set - Detail Update	03.28.25
	BP Set	04.24.25

06.19.25

TOTAL GROSS FLOO	R AREA	S.F
#102 7425 UNIT A1	TOTAL	124
MAIN		59
UPPER		64
#102B SUITE	A2	40
#101 7425 UNIT B1	TOTAL	124
MAIN		59
UPPER		64
#101B SUITE	B2	40
#202 7425 UNIT C1	TOTAL	122
MAIN		58
UPPER		63
#202B SUITE	C2	39
#201 7425 UNIT D1	TOTAL	122
MAIN		58
UPPER		63
#201B SUITE	D2	39

### STREET ADDRESS

BP Set 1.01

#101 & #102 7425 20 St. SE

LEGAL ADDRESS

LOTS 12 & 13, BLOCK 8, PLAN 955AV

PROJECT

OGDEN MID-BLOCK DEVELOPMENT **BUILDING 1** 

5012511101		
DESIGN/DRAWN: DK	CHE	ECKED: DK
PROJECT#	23	-3-CL-CN-036
SCALE		
AS	NOTED	

TITLE

DETAILS & NOTES

Z	ZONING			R-CG
	PAGE 3:20:11 025-06-19	A9	9	